

N 0°39'30" E

ATE

 $\stackrel{\mathcal{O}}{\vdash}$

SITE ACCESS EASEMENT

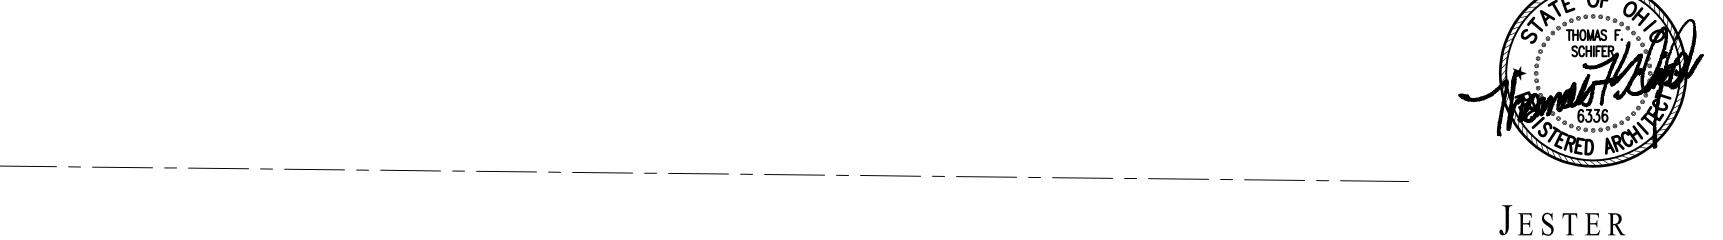

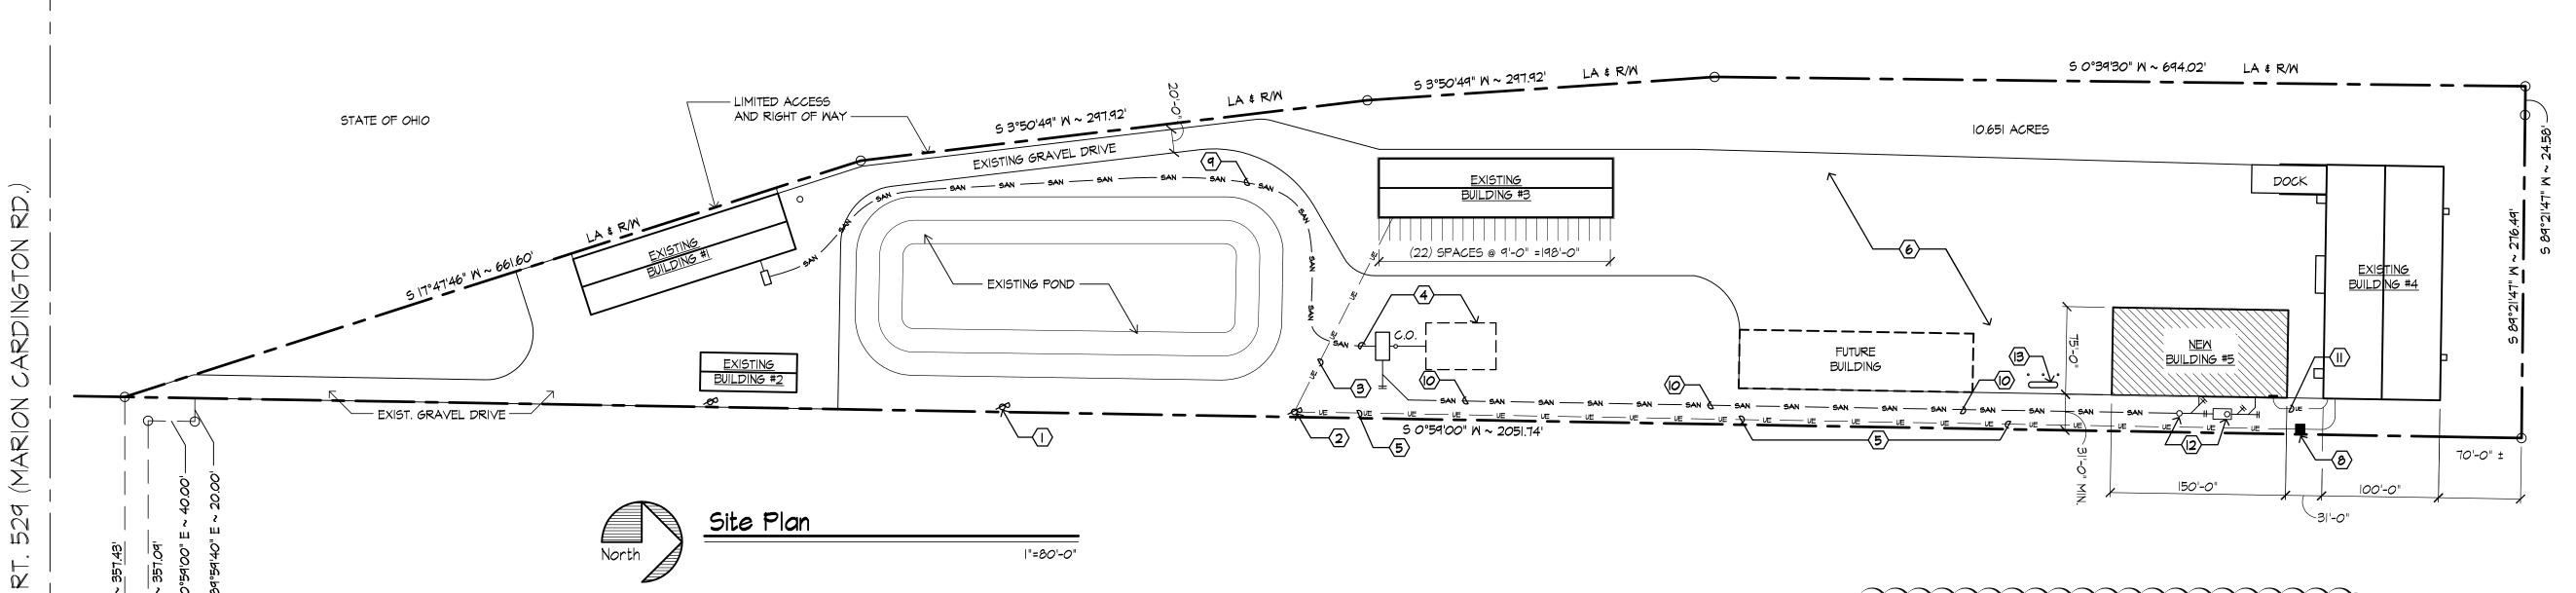

General Architectural Notes

. Govering Code - Ohio Building Code.

2. All dimensions shall be verified at the job by the General Contractor and each Subcontractor. The Architect must be notified of any discrepancies before proceeding with the work.

3. Dimensions are witnessed to face of masonry or to face of stud, unless otherwise noted.

4. Cutting into new work of other trades or into the new structure shall be done by the trade requiring the cutting. All cutting shall be done in a neat manner using saws where possible. Any damage to the work of the other trades or to the structure in excess of the cutting required, which, in the opinion of the architect is due to gence, shall be repaired at the expense of the trade who did the cutting. All patching and painting as a result of cutting and not to the negligent action shall be done by the Contractor at his

5. Do not cut or patch any work that will impair the structural load carrying capacity or reduce the load/deflection ration.

6. Provide adequate temporary support for work being cut and patched to prevent failure. Do not endanger other work. Provide adequate protection of other work during cutting and patching to prevent damage. Cut work by method least likely to damage work to be retained and adjoining work

7. All connections are to devolop the full streighth of the framing mambers, unless otherwise approved.

8. The structure is designed to be self-supporting and stable after the building is fully completed. It is solely the Contractor's responsibility to determine erection procedure and sequence and to insure the safety of the building and its component parts during erection. This includes the addition of whatever shoring, sheeting, temporary bracing, guys or tie downs which might be necessary. Such material shall remain the Contractor's property after the completion of the project.

9. Bench mark: New finish floor elevation 100' to be established at approximately 1'-0" above existing natural grade at the location of the new structure.

10. Soil Bearing pressure is assumed to be minium 1,500 PSF. Verify soil bearing pressure and subsoil conditions. Notify Architect immediately if conditions less then stated are encountered.

II. The Architect's responsibility is limited to the items shown on the Architectural drawings. Obtain Architect's specific approval prior t deviating from the drawings. Follow the best trade and engineering practices for the items not specifically detailed and indicated.

12. It is solely the Contractor's responsibility to follow the applicable safety codes and regulations during all phases of construction.

13. The General Contractor shall comply with all Building Code requirements of the local governing authority, and shall obtain and pay for all required permits, fees, and inspections, with the exception of local fees required for the Electrical portions of the work, which are the responsibility of the respective Subcontractor(s).

14. This is a "Builders Set" of drawings. The Architect's responsibility is limited to the items shown on the Architectural Drawings. Obtain Architect's specific approval prior to deviating from the drawings. It shall be the Contractor's sole responsibility to comply with standard building and construction practices and Manufacturer's recommendations for all the items not sepecifically indicated and detailed on the drawings. Follow the best trade practices and engineering for the items not specifically indicated and detailed on the drawings.

15. Should any of the detailed instructions shown on the drawings conflict with these notes, structural notes, structural notes, the specifications, or with each other, the strictest provision shall

16. All equipment furnished and work performed under the Contract Documents shall be granteed against defects in materials and workmanship for a peroid of one (1) year from the date of final acceptance. Any failure of equipment or work due to defects in material or workmanship shall be corrected by the Contractor at no cost to the Owner

17. In general, new materials and materials for repair conditions shall match similar items in quality, detail, profile, and finish as those already built into the work.

18. Construction joints permitted only where shown or as approved by the Architect.

19. The General Contractor shall be responsible for extending down spout leaders 2'-0" minimum beyond face of building and to concrete splash blocks. The Site Contractor shall make final connections to storm water drainage systems as required.

EI.OI | ELECTRICAL LIGHTING PLAN, NOTES, AND FIXTURE SCHEDULE FEI.02 | ELECTRICAL POWER PLAN, PANEL SCHEDULE, AND POWER RISER DIAGRAM .

INDEX OF DRAWINGS

A2.01 ENLARGED PLANS, SCHEDULES AND DETAILS

STRUCTURAL NOTES AND DETAILS

PLUMBING NOTES AND DETAILS

MECHANICAL PLAN

FOUNDATION PLAN, NOTES AND DETAILS

FIRST FLOOR PLAN, SCHEDULES AND DETAILS

BUILDING SECTIONS, WALL SECTION AND DETAILS

CI.OI SITE PLAN, NOTES AND LEGEND

ARCHITECTURAL

A5.01 | WALL SECTIONS

- Coded Notes (I) EXISTING UTILITY POLE BY ELECTRICITY COMPANY.
- (2) EXISTING WEATHER PROOF 400A, IPH SERVICE DISCONNECT MOUNTED AT POLE.

- (3) EXISTING UNDERGROUND SERVICE ENTRANCE CABLE, IN 2" CONDUIT TO EXISTING BUILDING.
- (4) EXISTING SANITARY SEPTIC SYSTEM AND LEACH FIELD TO REMAIN. PROTECT UNDERGROUND PIPING FROM DAMAGE DURING CONSTRUCTION.
- (5) EXISTING UNDERGROUND ELECTRIC SERVICE FROM EXISTING POLE TO NEW BUILDING BY ELECTRIC UTILITY COMPANY.
- (6) EXISTING 8" THICKNESS OF ODOT #304 COMPACTED STONE
- (7) EXTEND 6" PVC STORM DRAIN LINE TO SPLASH BLOCK AT EXISTING DRAINAGE SWALE.
- (8) EXISTING PAD MOUNTED TRANSFORMER BY ELECTRIC UTILITY COMPANY.
- (9) APPROXIMATE LOCATION OF EXISTING SANITARY LINE.
- NEW 2" DIAMETER PVC SANITARY LINE FROM GRINDER PUMP TO EXISTING SEPTIC SYSTEM. LOCATE CLEAN-OUTS AT MAXMIUM 150' INTERVALS.
- (II) NEW 200 AMP UNDERGROUND ELECTRIC SERVICE FROM EXISTING BUILDING #5. SEE ELECTRICAL DRAWINGS, SHEETS EI.01 AND EI.02
- (12) OIL AND SEDIMENT INTERCEPTOR AND SEWAGE EJECTOR. SEE SHEET PI.OI
- (B) PROPANE TANK WITH BOLLARDS, FENCING, OR OTHER APPROPRIATE PROTECTION, LOCATED, FURNISHED, AND INSTALLED BY OTHERS.

ARCHITECTS Our Marion Office...

SCHIFER

JONES

355 East Center Street Suite 200 Marion, Ohio 43302 Phone: (740) 382-6840 Fax: (740) 387-0318 E-mail: marion@jjsa.net

Our Columbus Office.. At Quarry Place 6209 Riverside Drive Suite 200 Dublin, Ohio 43017 Phone: (614) 761-1707 Fax: (614) 761-3996 E-mail: dublin@jjsa.net

. (c) 2001 by JESTER JONES SCHIFER ARCHITECTS, LTD. (c) 2007 by JESTER JONES SCHIFER ARCHITECTS, LTD.

THIS DRAVING AND SUBJECT MATTER THEREON,
AS MELL AS THE ASSOCIATED SPECIFICATIONS,
CONSTITUTE THE ORIGINAL AND UNPUBLISHED
WORK OF, AND ARE THE INSTRUMENTS OF THE CTS,
LTD. (LLSA) FOR USE SOLIFIER ARCHITECTS,
LTD. (LLSA) FOR USE SOLIFIER MITH RESPECT TO
THIS PROJECT. THESE INSTRUMENTS REMAIN THE
EXCLUSIVE PROPERTY OF JEA, WHO SHALL
RETAIN ALL COMMON LAM, STATUTORY AND
OTHER RESERVED RIGHTS, INCLUDING THE
COPYRIGHT THERETO, AND MAY NOT BE USED,
REPRODUCED, COPIED, OR ALTERED, IN WHOLE
OR PART, FOR ANY DIRECTS OR POSLECT
WITHOUT THE WRITTEN CONSENT OF JUSA.


.

Building

Storage Salt GreenKeeper

. 08590 000 September 18, 2008 DRAWN BY jet CHECKED BY: tfs REVISIONS


REV.: DATE:

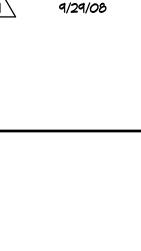

Building Code Data

THIS PROJECT CONSISTS OF CONSTRUCTION OF A NEW SALT STORAGE BUILDING INCLUDING ADDITIONAL STORAGE OF LAWN SERVICE AND BUILDING MAINTENANCE EQUIPMENT AND MATERIALS, I.E. FERTILIZER SPREADERS, CORE AERATION, THATCHING, AND LANDSCAPING EQUIPMENT, ETC., AND OFF SEASON EQUIPMENT FOR SNOW REMOVAL, SNOW PLOWS, AND SALT SPREADERS, ETC. THE BUILDING IS OF PRE-ENGINEERED STEEL FRAME TYPE CONSTRUCTION, WITH METAL SIDING AND ROOFING. THE BUILDING IS UNHEATED IN THE SALT STORAGE AREA, BUT HAS RADIANT FLOOR HEATING IN THE EQUIPMENT STORAGE AND EMPLOYEE LOUNGE PORTION OF THE BUILDING.

CONSTRUCTION TYPE (CHAPTER	#6):	2B	USE GROUP :	5-2	STORAGE, LOW HAZARD
BUILDING DATA:	AREA	HEIGHT	ALLOWABLE A	REA (503):	5-2 - 17,500 sq.ft.
MEZZANINE AREA:	11,250 sq.ft. 756 sq.ft.	8'-0" <u>+</u>			
# OF EXITS REQUIRED:	2 (AS PER 1014.3)		ALLOMABLE HE	EIGHT (503):	3 STORY(S)
ADJUSTED ALLOWABLE AREA:			FIRE RESISTAN	CE DATA: OBC TA	ABLE 601
FROM TABLE 503:	500 sq.ft.		STRUCTURAL F	RAME: O HOUR	
	,125 sq.ft. * SEE	CALCULATION	EXTERIOR BEA	RING WALLS: OHO	DUR
*FRONTAGE INCREASE MODIFICATION AND INCREASE	0,625 sq.ft. <u>ATION</u> (SECTION 506.	2):	INTERIOR BEAR	RING WALLS: O HO	JR
$I_{F} = 100 \left[\frac{F}{P} - 0.25 \right] \frac{W}{30}$			FLOOR CONSTR	RUCTION: O HOUR	
$I_{\text{f}} = 100 \left[\frac{600}{600} - 0.25 \right] \frac{30}{30} = 0.00$	75%		ROOF CONSTRU	JCTION: O HOUR	
A = 17,500 + (17,500)(75/100) =	30,625 sq ft		FIRE SUPRESSION	ON SYSTEM: N/A	
F = 450' (OPEN BUILDING PERIN P = 450' (BUILDING PERIMETER))		FIRE ALARM A	ND FIRE/SMOKE DE	TECTION SYSTEM: NOT REQUIRED
W = 30' (WIDTH OF PUBLIC WAY)				

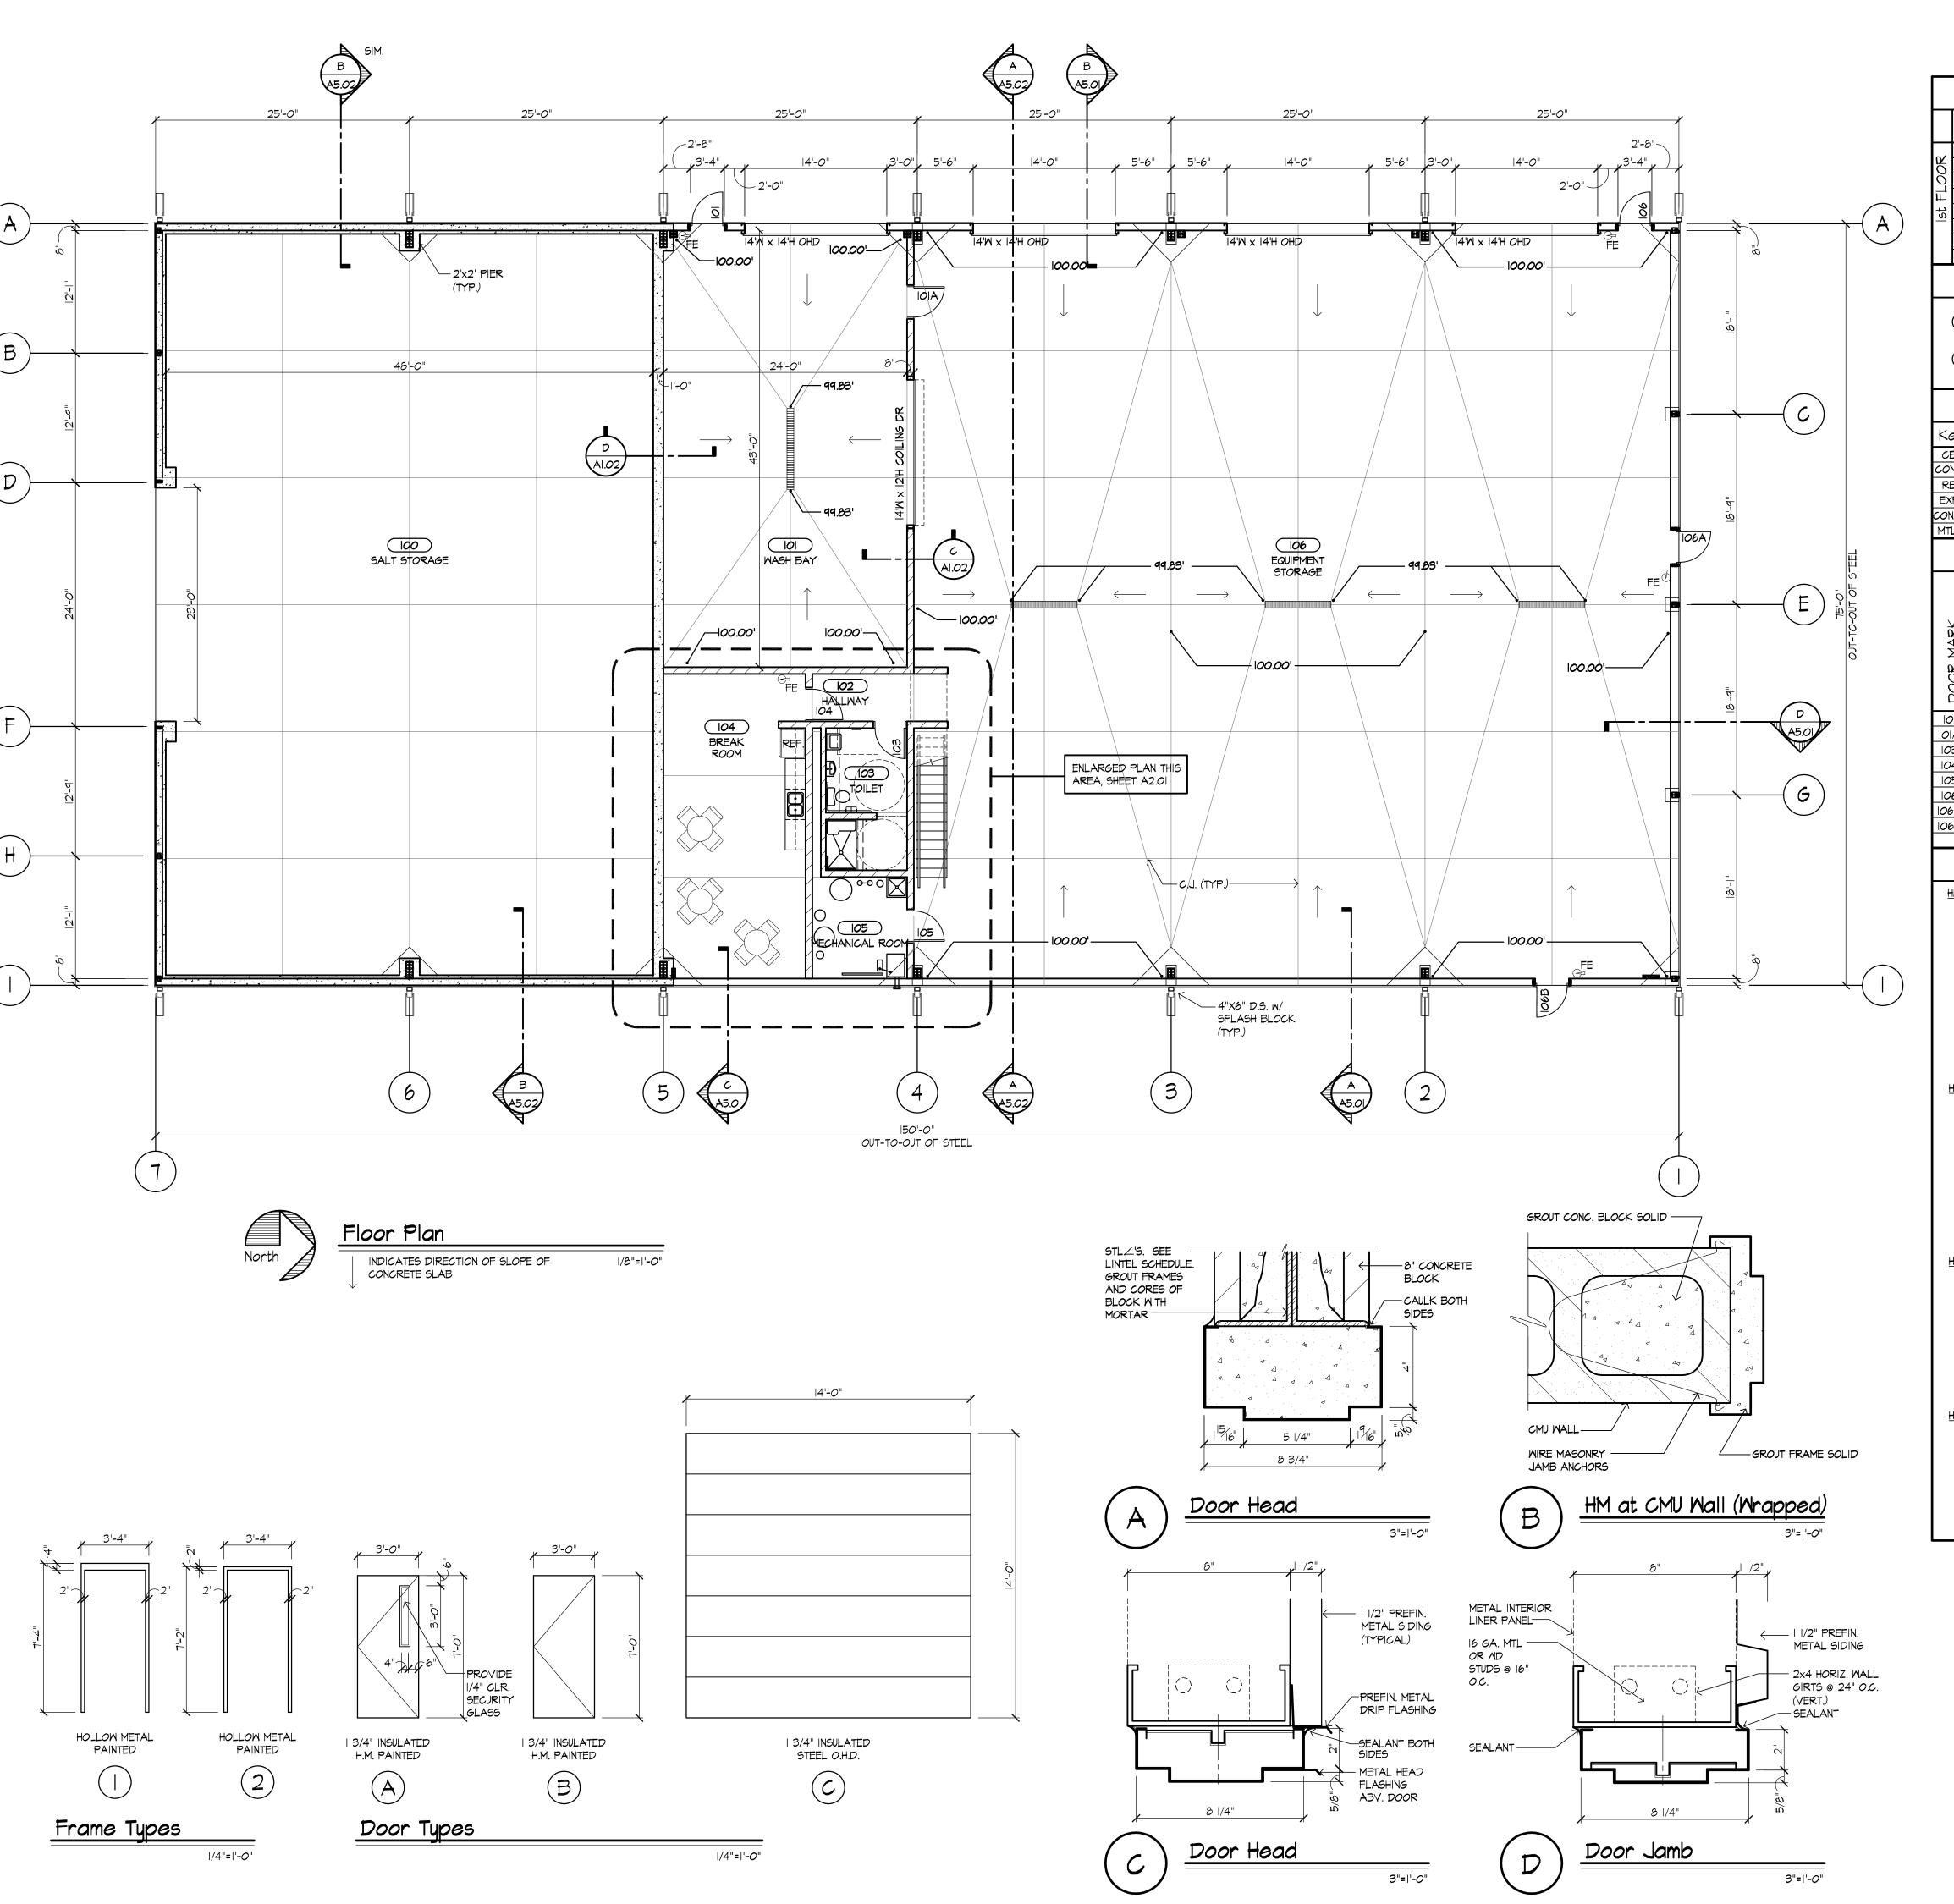



Finish Schedule Notes

PAINT EXPOSED STRUCTURAL STEEL, BAR JOISTS, CONDUIT, METAL DUCTWORK, ETC. THAT WILL REMAIN IN VIEW IN THE FINISHED STRUCTURE.

(2) INSTALL METAL LINER PANEL FROM TOP OF CONCRETE WALLS TO ROOF STRUCTURE ABOVE.


		Finish Schedule Legend
Key	ltem	Specification
CB-I	Concrete Block	Concrete Block, Paint
CONC-I	Concrete	Clean and Seal Concrete Floor Slab, See Specifications
RB-I	Resilient Base	6" Resilient Base, 1/8" Thickness, Roppe Match Mates)
EXP-I	Exposed Structure	Exposed Structure Above, Paint Exposed Structure
ONC-2	Concrete	Cast-In-Place Concrete Walls
MTL-L	Liner Panel	Factory Finished Corrugated Metal Liner Panel to 7'-6" A.F.F. Unless Noted Otherwise

Door Schedule


				FRAME						REMARK			
	SIZE				GLA	455			DET,	AILS			
DOOR MARK		T I K	MATERIAL	∃d↓↓	М.	Н.	MATERIAL	∃d↓⊥	HEAD/SILL	AMB.	HDM. SET NO	LABEL	
0	3'-0" × 7'-0"	1 3/4"	H.M	В			H.M.	2	C	D			
10 A	3'-0" x 7'-0"	3/4"	H.M	Α	4"	36"	H.M.	_	Α	В	Э		
103	3'-0" x 7'-0"	3/4"	H.M	В			H.M.	1	Α	В	4		
104	3'-0" x 7'-0"	1 3/4"	H.M	Α	4"	36"	H.M.		Α	В	3		
105	3'-0" x 7'-0"	3/4"	H.M	В			H.M.		Α	В	3		
106	3'-0" x 7'-0"	1 3/4"	H.M	В			H.M.	2	C	D	1		
106A	3'-0" x 7'-0"	1 3/4"	H.M	В			H.M.	2	C	D	2		
106B	3'-0" x 7'-0"	1 3/4"	H.M	В			H.M.	2	C	D	2		
		I	I		1					I			

Door Hardware Sets

HW SET	<u>r</u> 01 (D0	ORS 101, 106)			
3	EΑ	HINGE	5BBI 4.5 x 4.5 NRP	630	IVES
1	EΑ	ENTRANCE LOCKSET	ND93PD (VANDLGARD) RHODES	626	SCHLAGE
1	EA	SURFACE CLOSER	4IIIMC	689	LCN
2	EA	KICK PLATE	8400 8"x2" LDW	630	IVES
1	EA	SWEEP	200NA	ALUM	NGP
1	SET	SEALS	IIONA	ALUM	NGP
1	EA	DRIP CAP	17	ALUM	NGP
I	EA	THRESHOLD	4425 (CAST ALUMINUM)	ALUM	NGP
HM SE	<u>T</u> 02 (D0	OORS 106A, 106B)			
3	EA	HINGE	5BBI 4.5 x 4.5 NRP	630	IVES
1	EA	EXIT LOCK	ND60PD, RHODES	626	SCHLAGE
1	EA	SURFACE CLOSER	4IIIMC	689	LCN
1	EA	SWEEP	200NA	ALUM	NGP
1	SET	SEALS	IIONA	ALUM	NGP
1	EA	DRIP CAP	17	ALUM	NGP
1	EA	THRESHOLD	4425 (CAST ALUMINUM)	ALUM	NGP
HM SE	<u>T</u> 03 (D0	OORS 101A, 104, 105)			
3	EA	HINGE	5BBI 4.5 x 4.5 NRP	626	IVES
1	EA	CLASSROOM LOCK SET	ND70PD, RH0DES	626	SCHLAGE
1	EA	SURFACE CLOSER	4011 / 4111MC	689	LCN
1	EA	KICK PLATE	8400 8"x2" LDW	<i>630</i>	IVES
1	EA	WALL STOP	MS407CVX	626	IVES
1	EA	FLOOR STOP	FS 444 (DOOR 105 ONLY)	626	IVES
HM SE	<u>T</u> 04 (D0	00R 103)			
3	EA	HINGE	FBBI 4.5 x 4.5	626	IVES
1	EA	PRIVACY SET	ND405	626	SCHLAGE
1	EA	SURFACE CLOSER	4011MC/4111MC	689	LCN
1	EA	KICK PLATE	8400 8"x2" LDW	630	IVES
1	EΑ	WALL STOP	MS407CVX	626	IVES

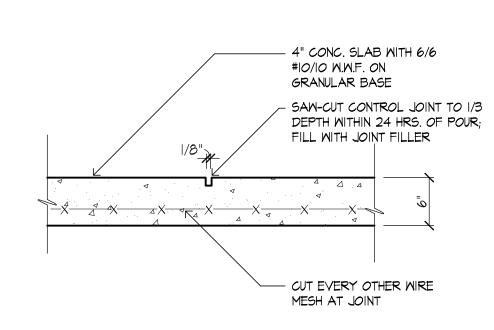



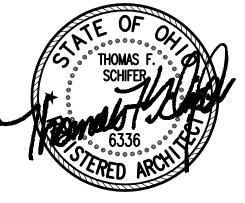

JESTER JONES SCHIFER ARCHITECT

Our Marion Office...
355 East Center Street
Suite 200
Marion, Ohio 43302
Phone: (740) 382-6840
Fax: (740) 387-0318
E-mail: marion@jjsa.net

Our Columbus Office...
At Quarry Place
6209 Riverside Drive
Suite 200
Dublin, Ohio 43017
Phone: (614) 761-1707
Fax: (614) 761-3996

E-mail: dublin@jjsa.net

(c) 2001 by JESTER JONES SCHIFER ARCHITECTS, LTD.

THIS DRAWING AND SUBJECT MATTER THEREON,
AS WELL AS THE ASSOCIATED SPECIFICATIONS,
CONSTITUTE THE ORIGINAL AND UNPULSHED
WORK OF, AND ARE THE INSTRUMENTS OF
SERVICE OF, JESTER, JONES SCHIFER ARCHITECTS,
LTD. (LJSA) FOR USE SOLELY MITH RESPECT TO
THIS PROJECT. THESE INSTRUMENTS REMAIN THE
EXCLUSIVE PROPERTY OF JUSA, WHO SHALL
RETAIN ALL COMMON LAW, STATUTORY AND
OTHER RESERVED RIGHTS, INCLUDING THE
COPYRIGHT THERETO, AND MAY NOT BE USED,
REPRODUCED, COPIED, OR ALTERED, IN WHOLE
OR PART, FOR ANY PURPOSE OR PROJECT
WITHOUT THE WRITTEN CONSENT OF JUSA.

.

GreenKeeper
GreenKeeper
1798 Marion Cardington Rd. East

08590_000


REVISIONS

September 18, 2008


DRAWN BY: jet
CHECKED BY: tfs


REV: DATE:


9/29/08

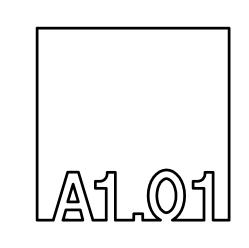


|"=|'-0"

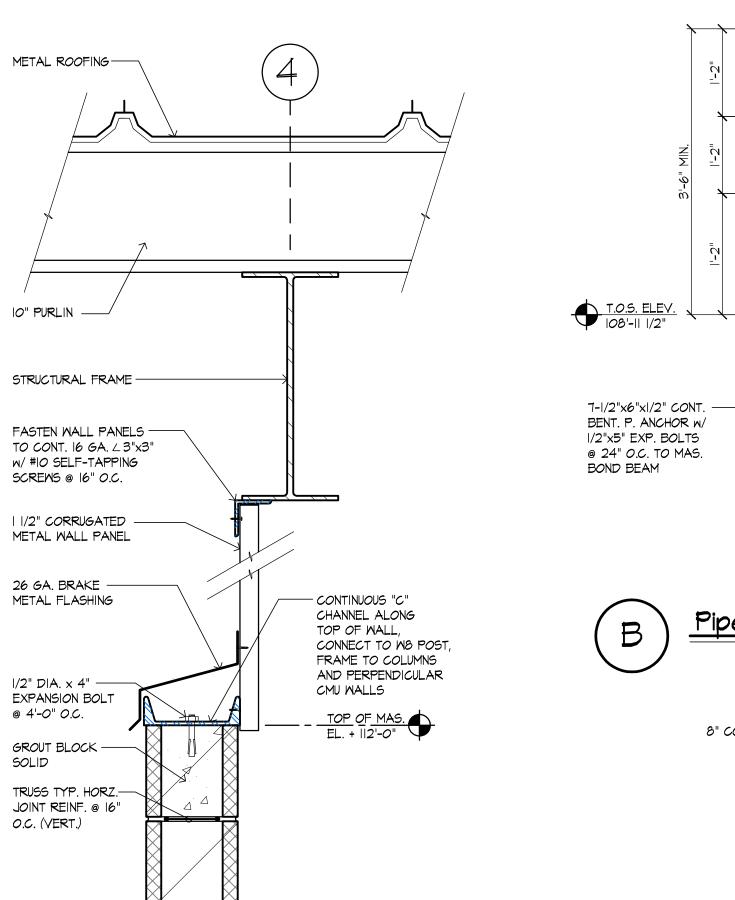


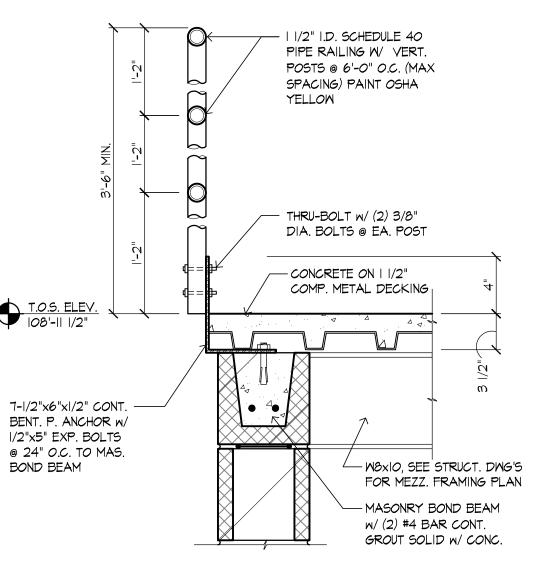

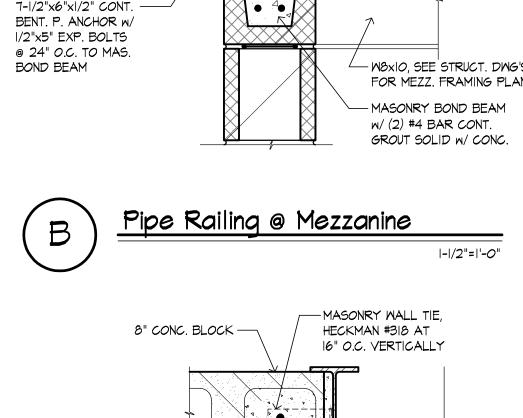

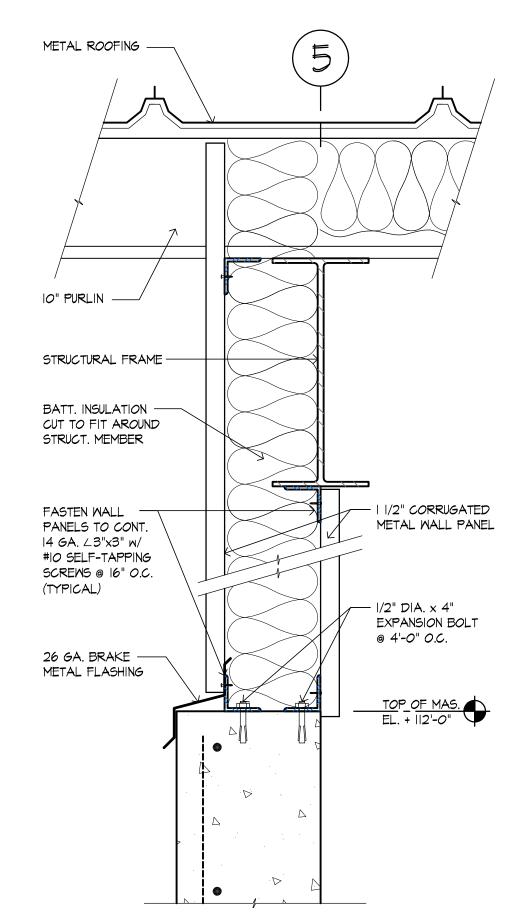



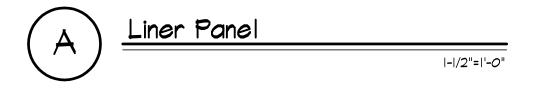




- COILING

DOOR TRACK

W8xl3 P0ST-EA. SIDE

1ark 🔾	Description	Manuf.	Model #	Remarks
T-D	GRAB BAR, 36"x54" 'L' SHAPE	BOBRICK	B-5837.99	MOUNTED AT 34" A.F.F.
T-3	TOILET TISSUE DISPENSER	BOBRICK	B-7686	SURFACE MOUNTED AT 19" A.F.F. AND 36" FROM REAR WALL
(1-5)	PAPER TOWEL DISPENSER	BOBRICK	B-262	MOUNT AT 48" A.F.F. TO BOTTOM OF UNIT
(-6)	SOAP DISPENSER	BOBRICK	B-2014	WALL MOUNTED, SHELF STYLE, MOUNT AT BOTTOM EDGE OF MIRRIOR
(-7)	TOWEL/ROBE PIN	BOBRICK	B-76717	SURFACE MOUNTED AT 54" A.F.F.
(-10	CHANNEL FRAME MIRROR (18"x36")	BOBRICK	B-165-1336	CONCEALED FASTENERS, MOUNT BOTTOM AT 38" A.F.F.

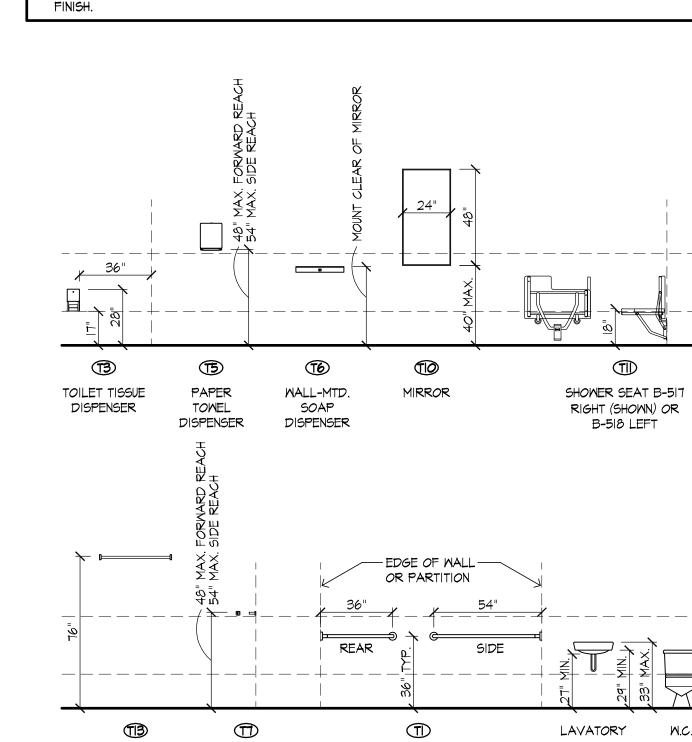


GRAB BAR

2. ALL ACCESSORIES TO BE STAINLESS STEEL WITH SATIN


SHOWER

CURTAIN ROD


TOWEL PIN

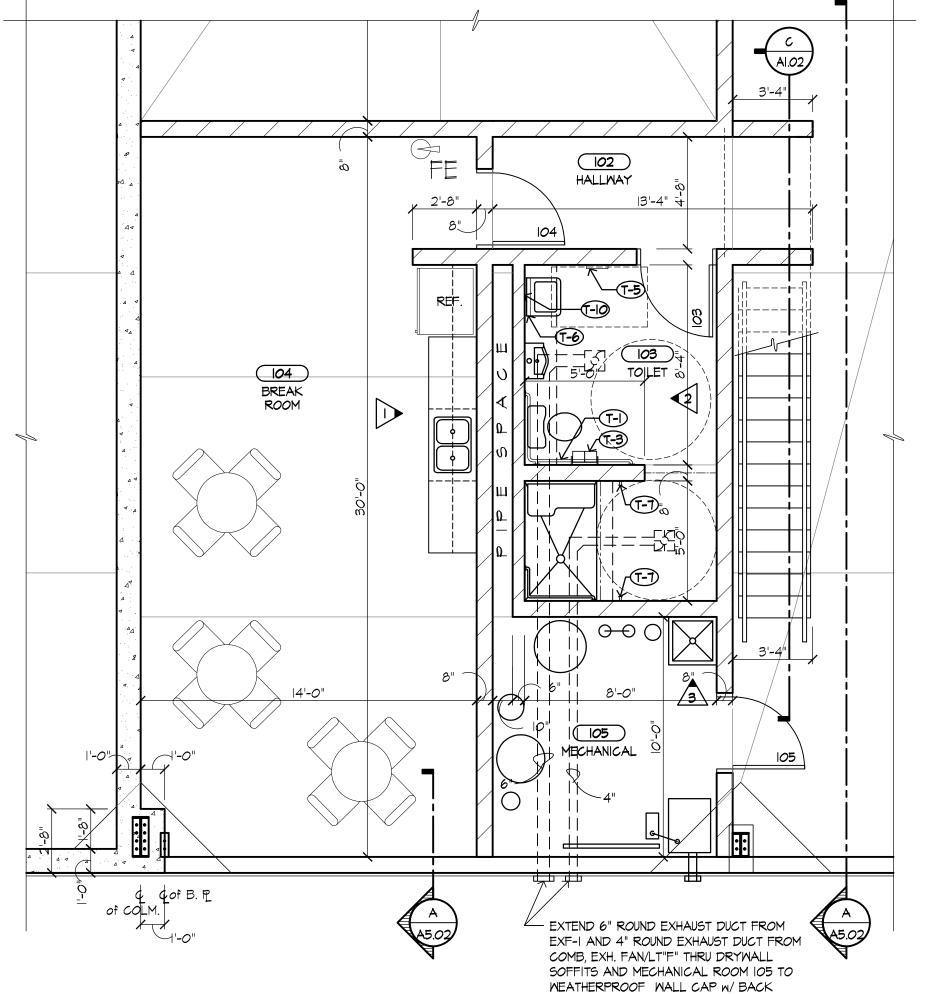

DRAFT DAMPER AT EXTERIOR WALL

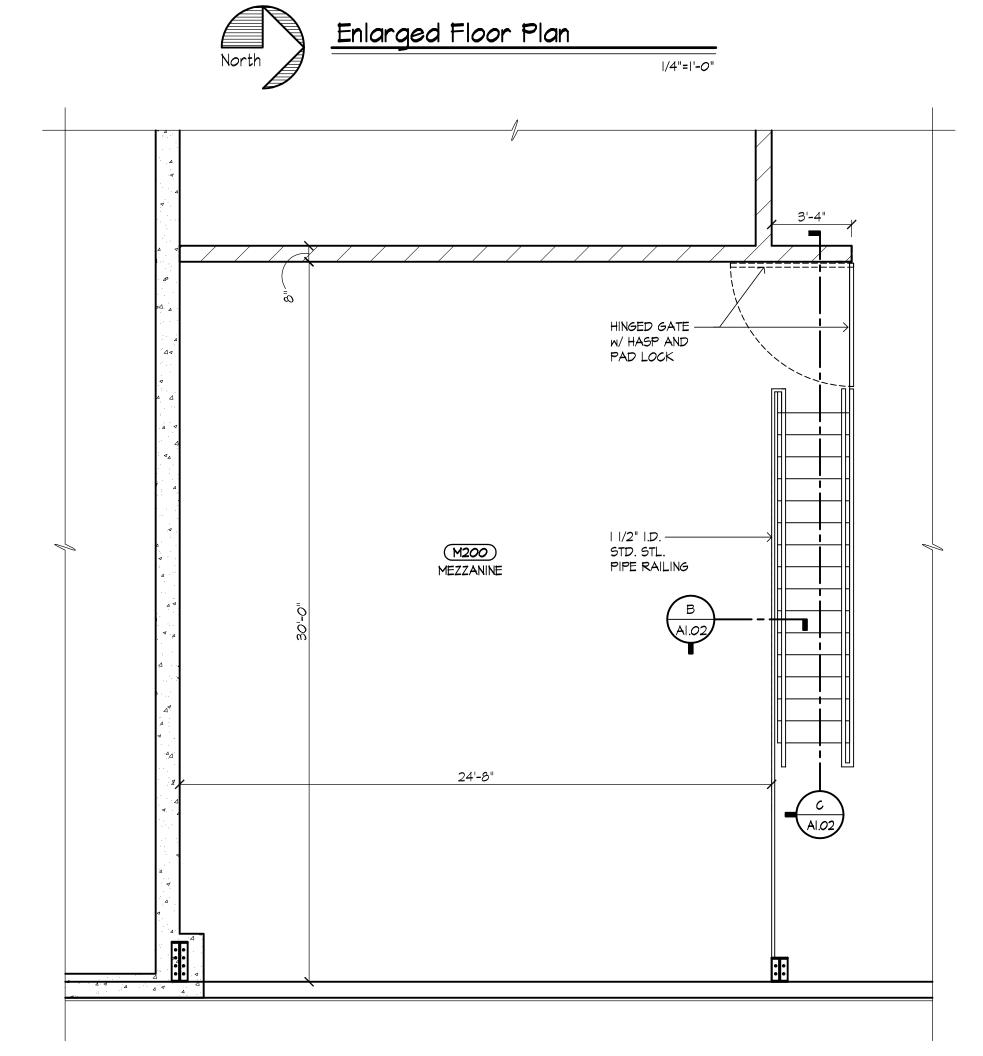



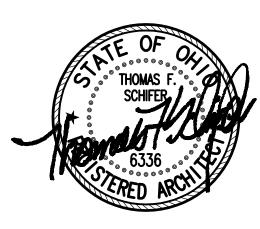

JESTER JONES SCHIFER

Our Marion Office...
355 East Center Street
Suite 200
Marion, Ohio 43302
Phone: (740) 382-6840
Fax: (740) 387-0318
E-mail: marion@jjsa.net

Our Columbus Office...
At Quarry Place
6209 Riverside Drive
Suite 200
Dublin, Ohio 43017
Phone: (614) 761-1707
Fax: (614) 761-3996
E-mail: dublin@jjsa.net

E-mail: dublin@jjsa.net

(c) 2001 by LESTER JONES SCHIFER ARCHITECTS, LTD.

THIS DRAWING AND SUBLECT MATTER THEREON,
AS WELL AS THE ASSOCIATED SPECIFICATIONS,
CONSTITUTE THE ORIGINAL AND UNPUBLISHED
WORK OF, AND ARE THE INSTRUMENTS OF
SERVICE OF, LESTER JONES SCHIFER ARCHITECTS,
LTD, (LLISA) FOR USE SOLILLY WITH RESPECT TO
THIS PROJECT. THESE INSTRUMENTS REMAIN THE
EXCLUSIVE PROPERTY OF JUSA, WHO SHALL
RETAIN ALL COMMON LAW, STATUTORY AND
OTHER RESERVED RIGHTS, INCLIDING THE
COPPRIGHT THERETO, AND MAY NOT BE USED,
REPRODUCED, COPIED, OR ALTERED, IN WHOLE
OR PART, FOR ANY PURPOSE OR PROJECT
WITHOUT THE WRITTEN CONSENT OF JUSA.

GreenKeeper Salt Storage Building #5


GreenKeeper

Salt Storage Building #5

GreenKeeper

1798 Marion Cardington Rd. East

Marion

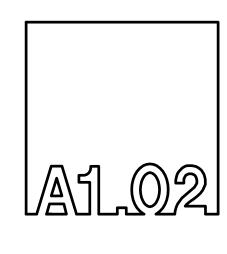



REVISIONS


DATE:

9/29/08

REV.:

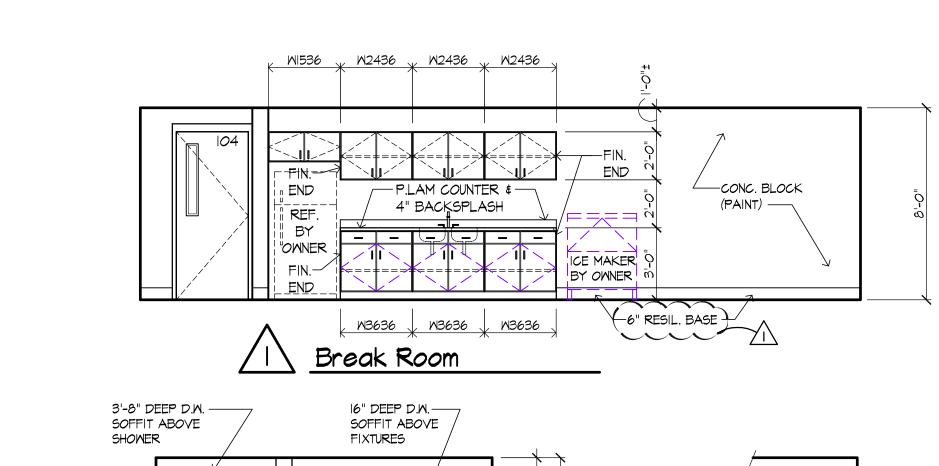


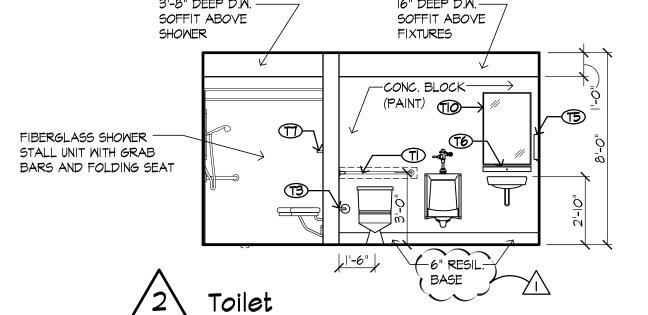


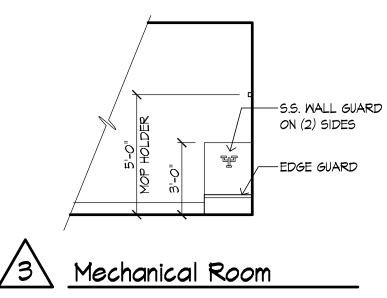

INTERIOR ELEVATIONS

1/4"=1'-0"

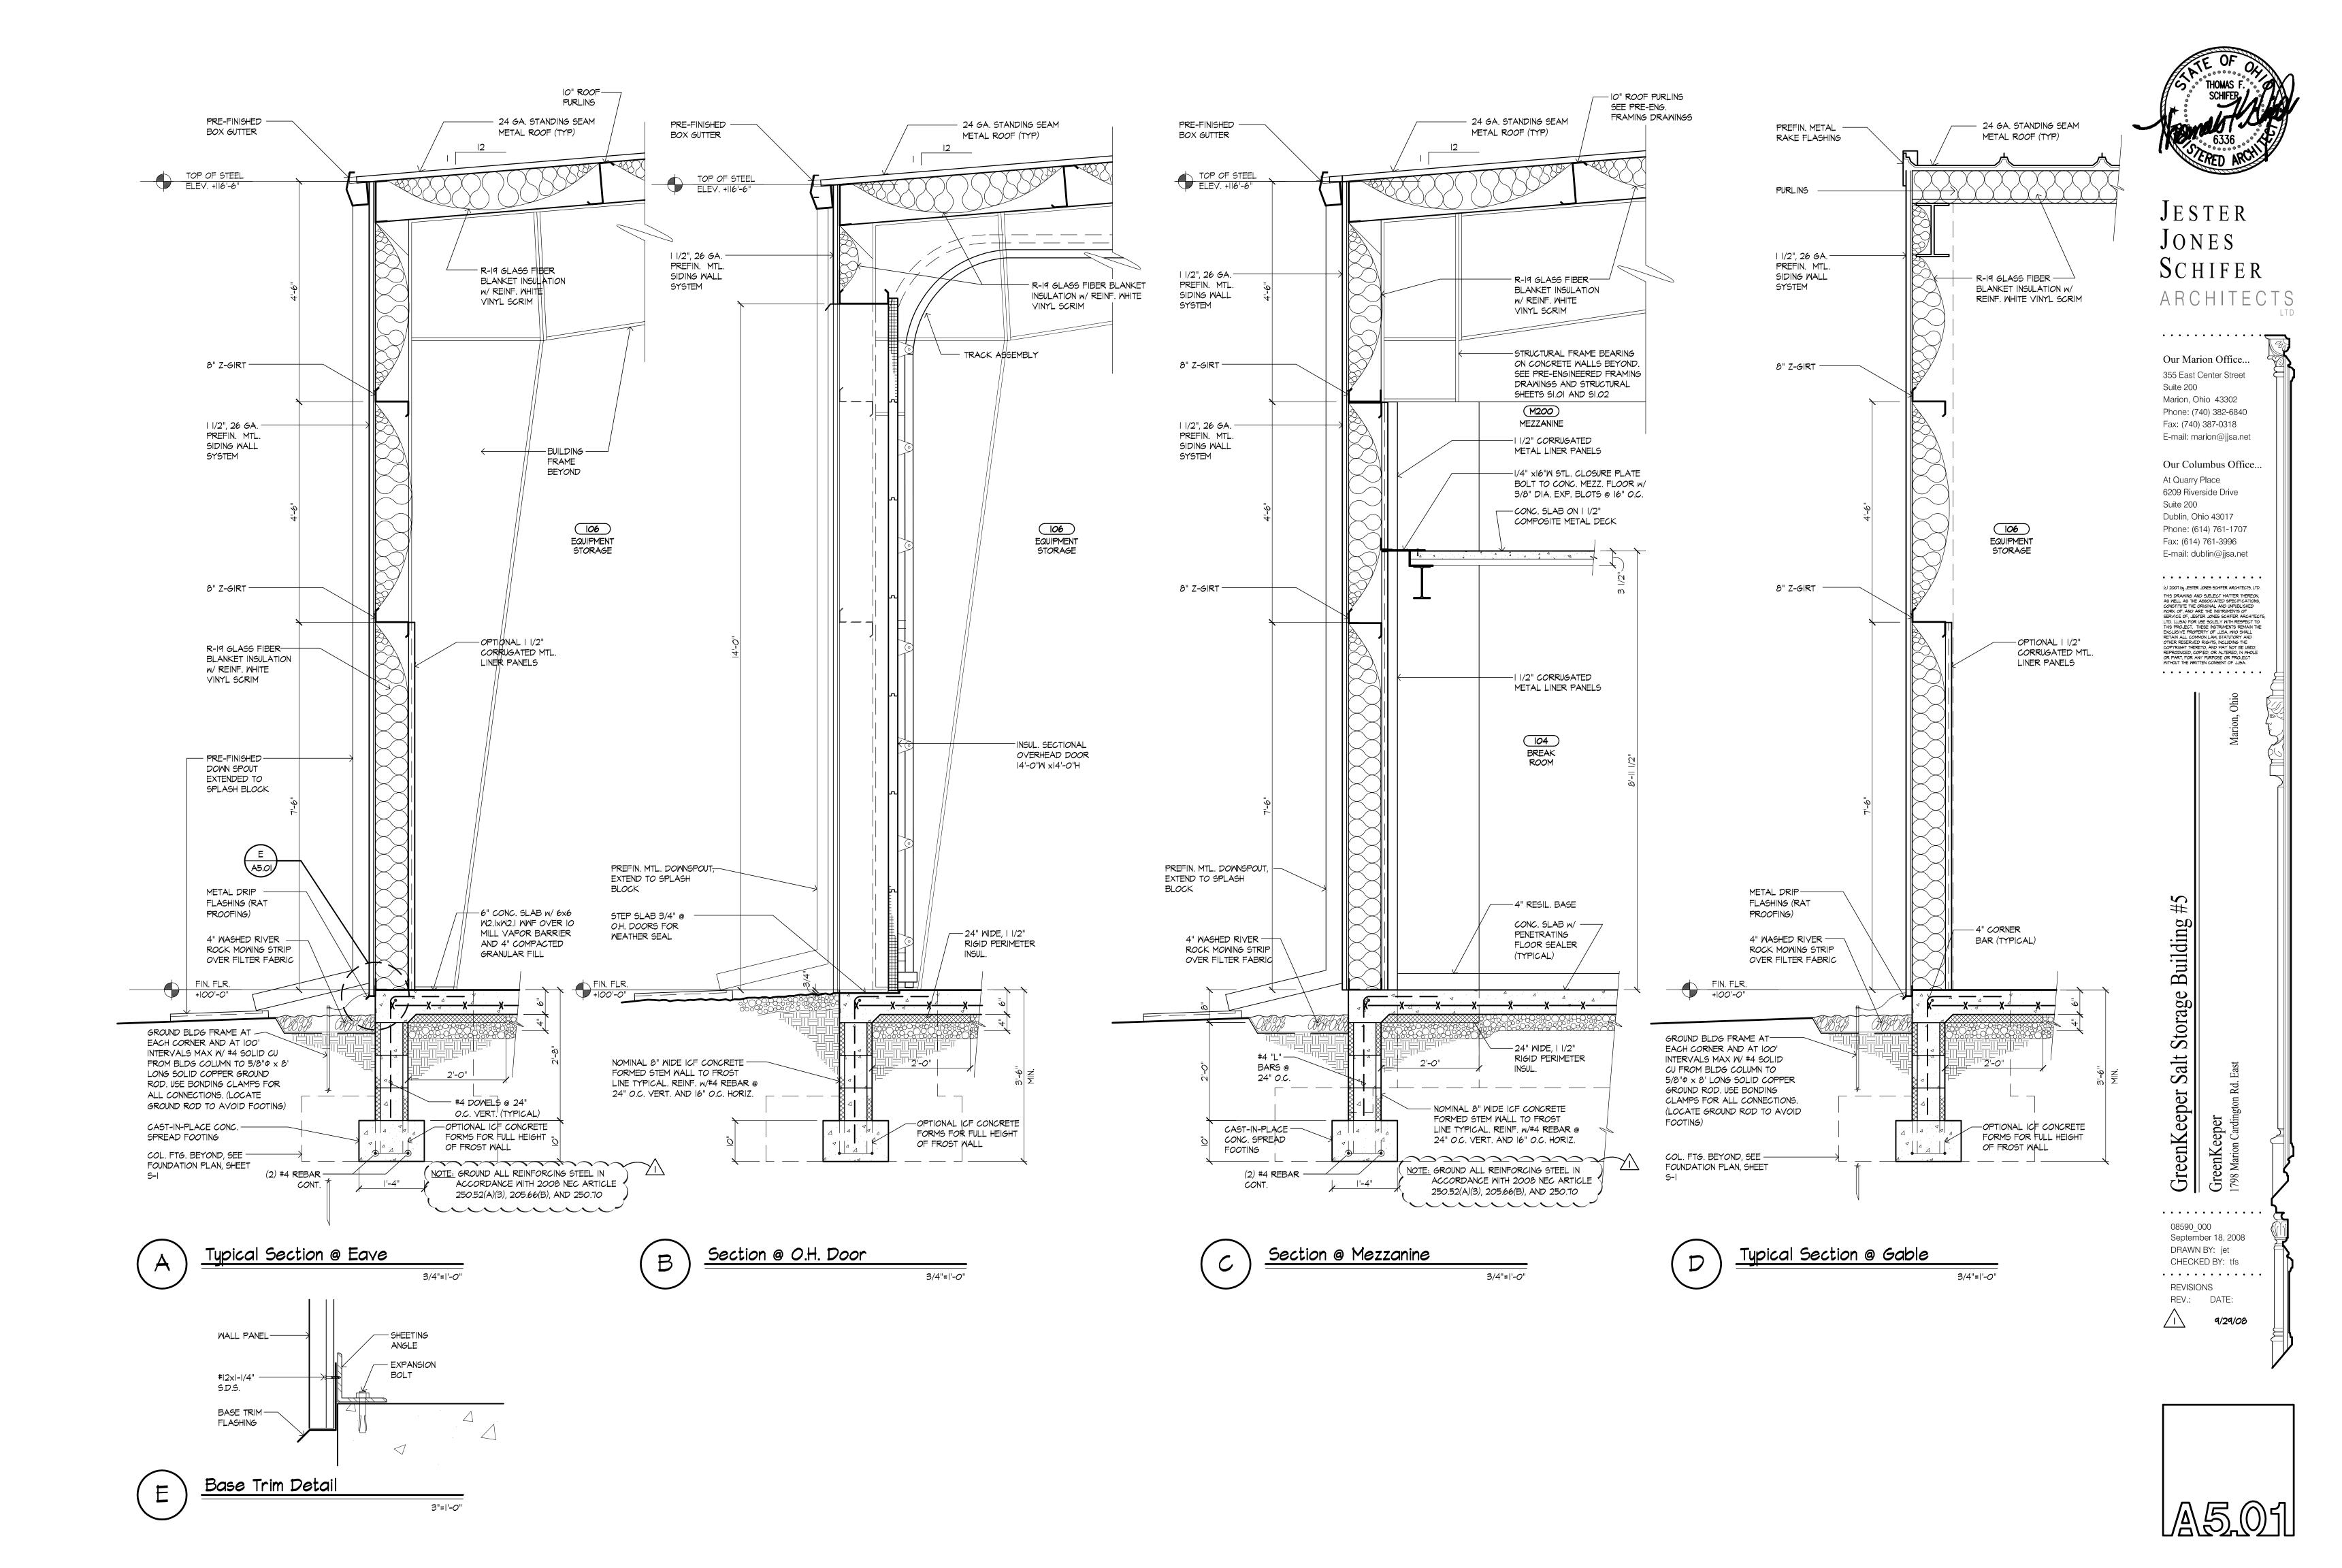

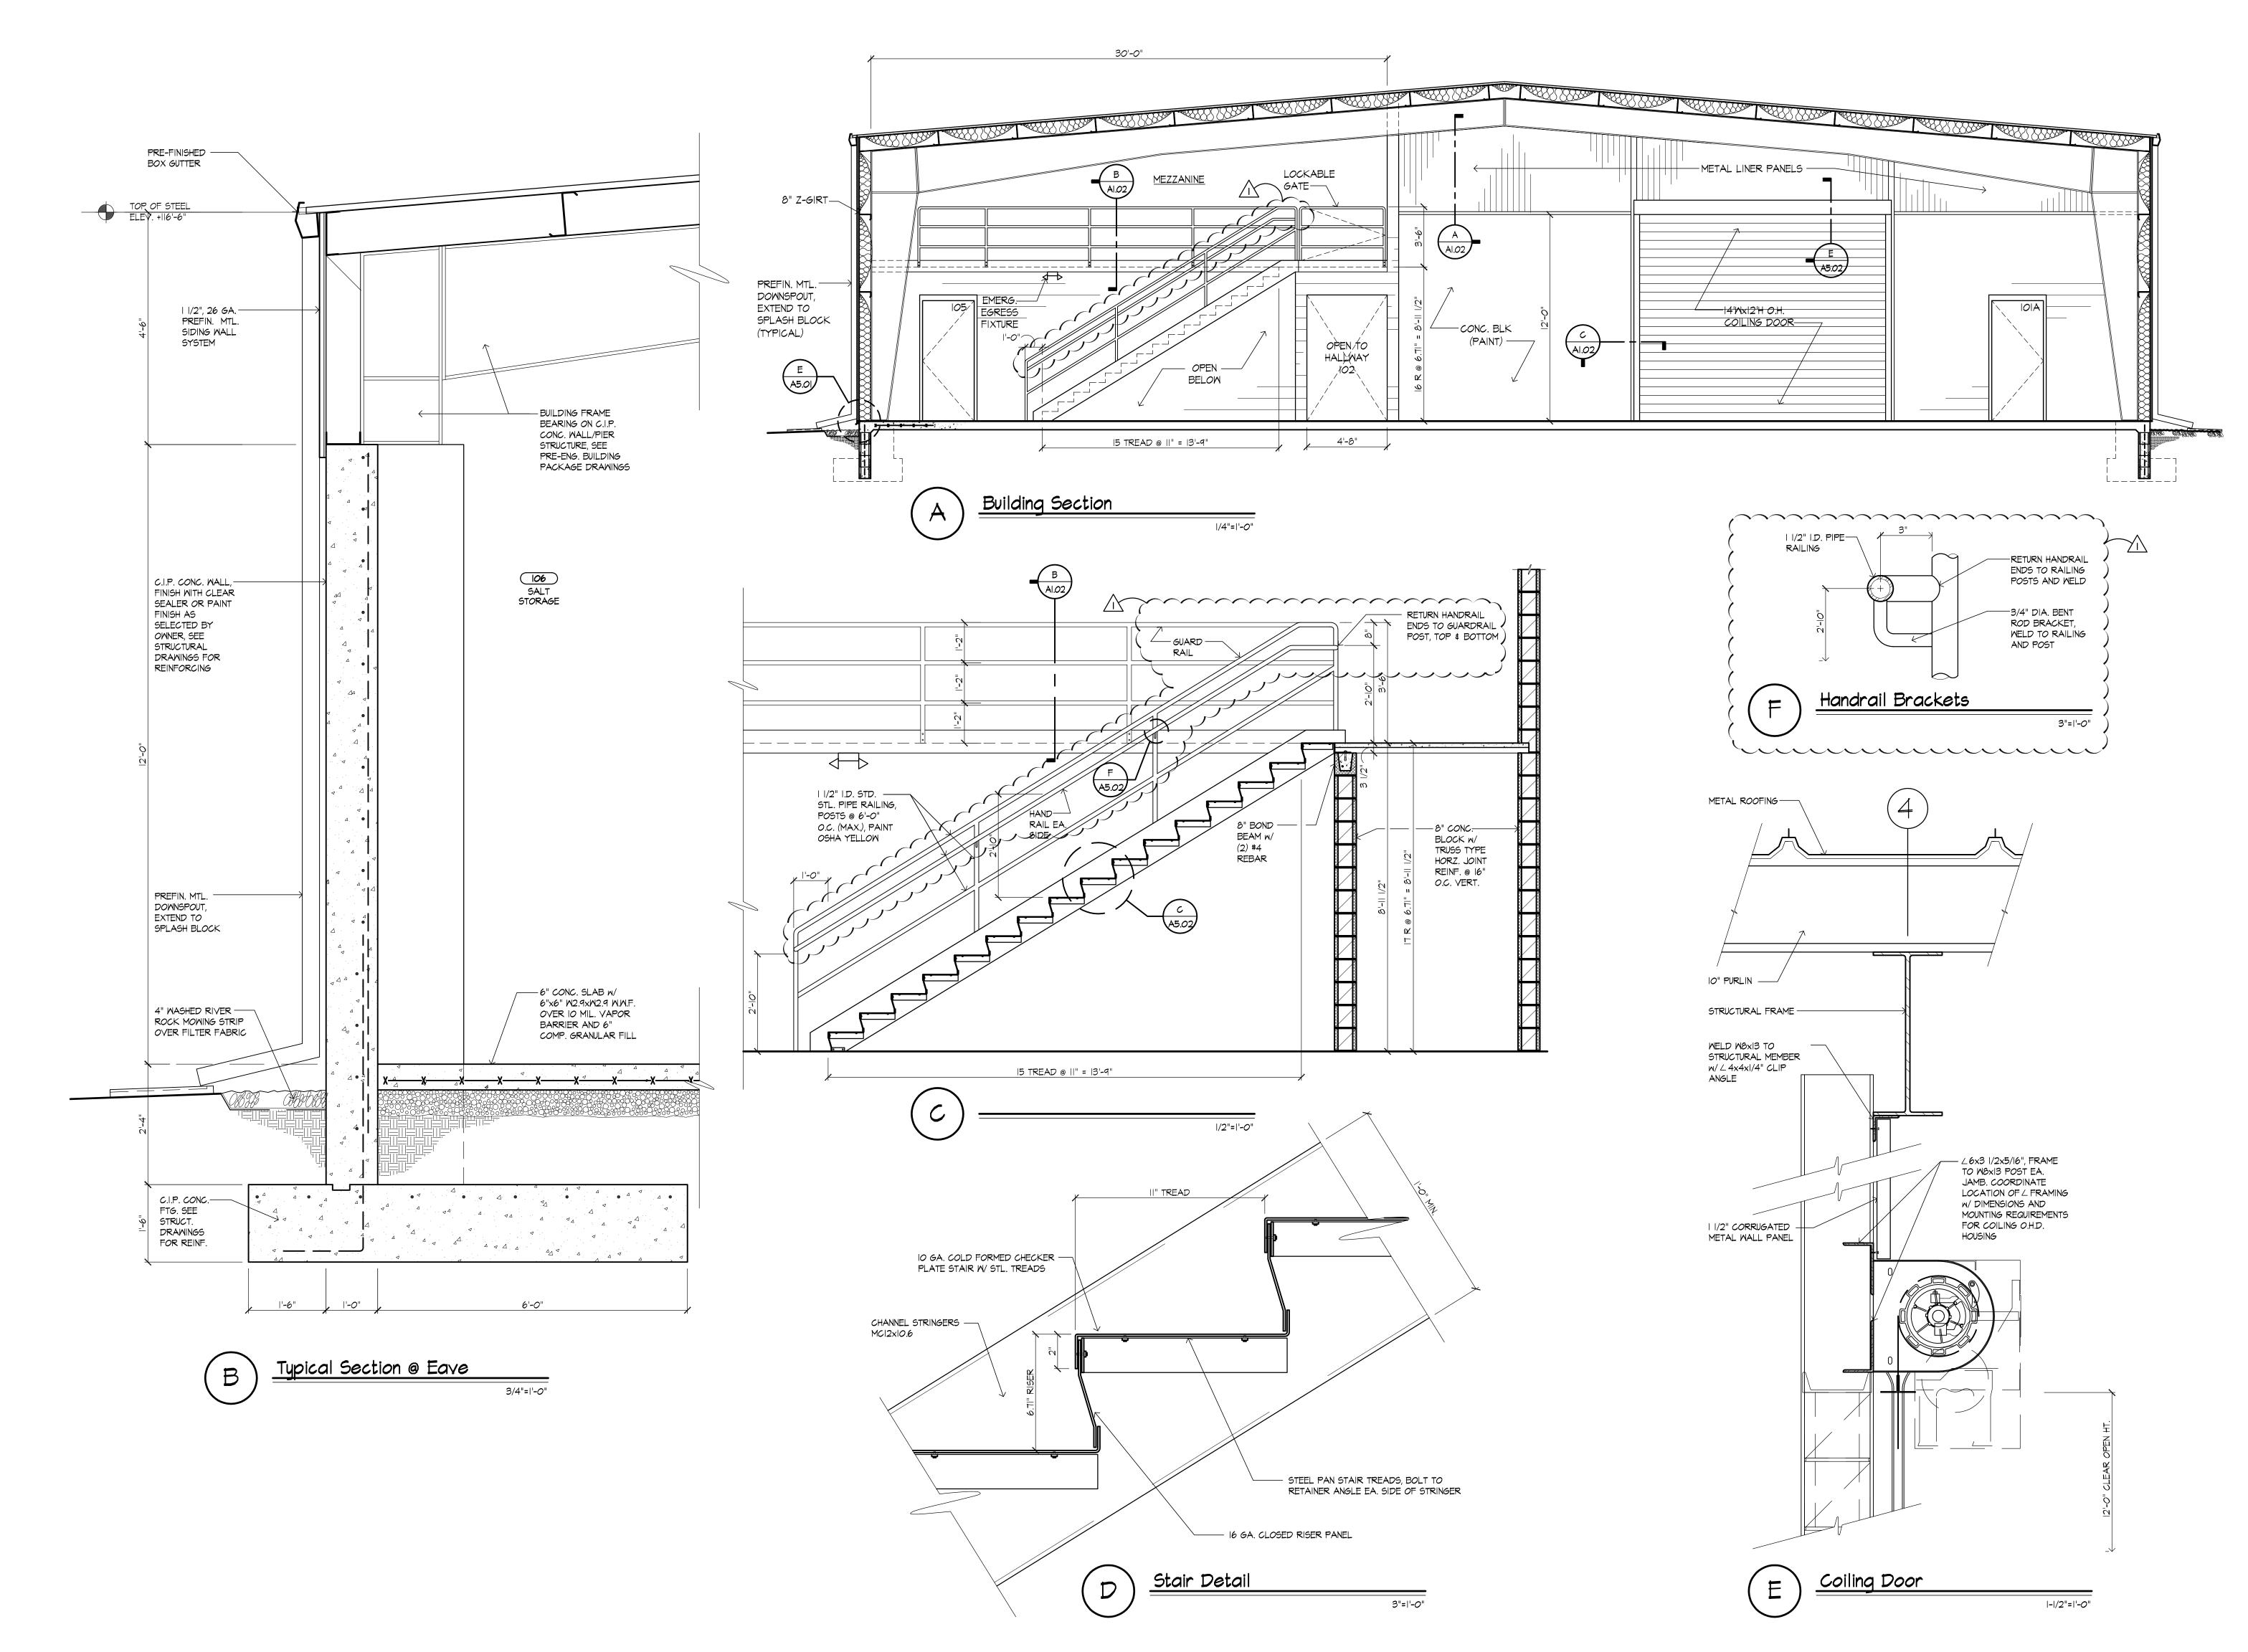



JESTER JONES SCHIFER

Our Marion Office...
355 East Center Street
Suite 200
Marion, Ohio 43302
Phone: (740) 382-6840
Fax: (740) 387-0318
E-mail: marion@jjsa.net

Our Columbus Office...
At Quarry Place
6209 Riverside Drive
Suite 200
Dublin, Ohio 43017
Phone: (614) 761-1707
Fax: (614) 761-3996
E-mail: dublin@jjsa.net

(c) 2001 by LESTER JONES SCHIFER ARCHITECTS, LTD.
THIS DRAWING AND SUBLECT MATTER THEREON,
AS NELL AS THE ASSOCIATED SPECIFICATIONS,
CONSTITUTE THE ORIGINAL AND UNPUBLISHED
WORK OF, AND ARE THE INSTRUMENTS OF
SERVICE OF, LESTER JONES SCHIFER ARCHITECTS,
LTD. (JJSA) FOR USE SOLELY MITH RESPECT TO
THIS PROJECT. THESE INSTRUMENTS REMAIN THE
EXCLUSIVE PROPERTY OF JJSA, WHO SHALL
RETAIN ALL COMMON LAW, STATUTORY AND
OTHER RESERVED RIGHTS, INCLUDING THE
COPYRIGHT THERETO, AND MAY NOT BE USED,
REPRODUCED, COPIED, OR ALTERED, IN WHOLE
OR PART, FOR ANY THEPOSE OR PROJECT
WITHOUT THE WRITTEN CONSENT OF JJSA.

GreenKeeper
GreenKeeper

GreenKeeper

1798 Marion Cardington Rd. East

Marion, C

08590_000

REVISIONS


REV.: DATE:


September 18, 2008 DRAWN BY: jet

CHECKED BY: tfs



9/29/08

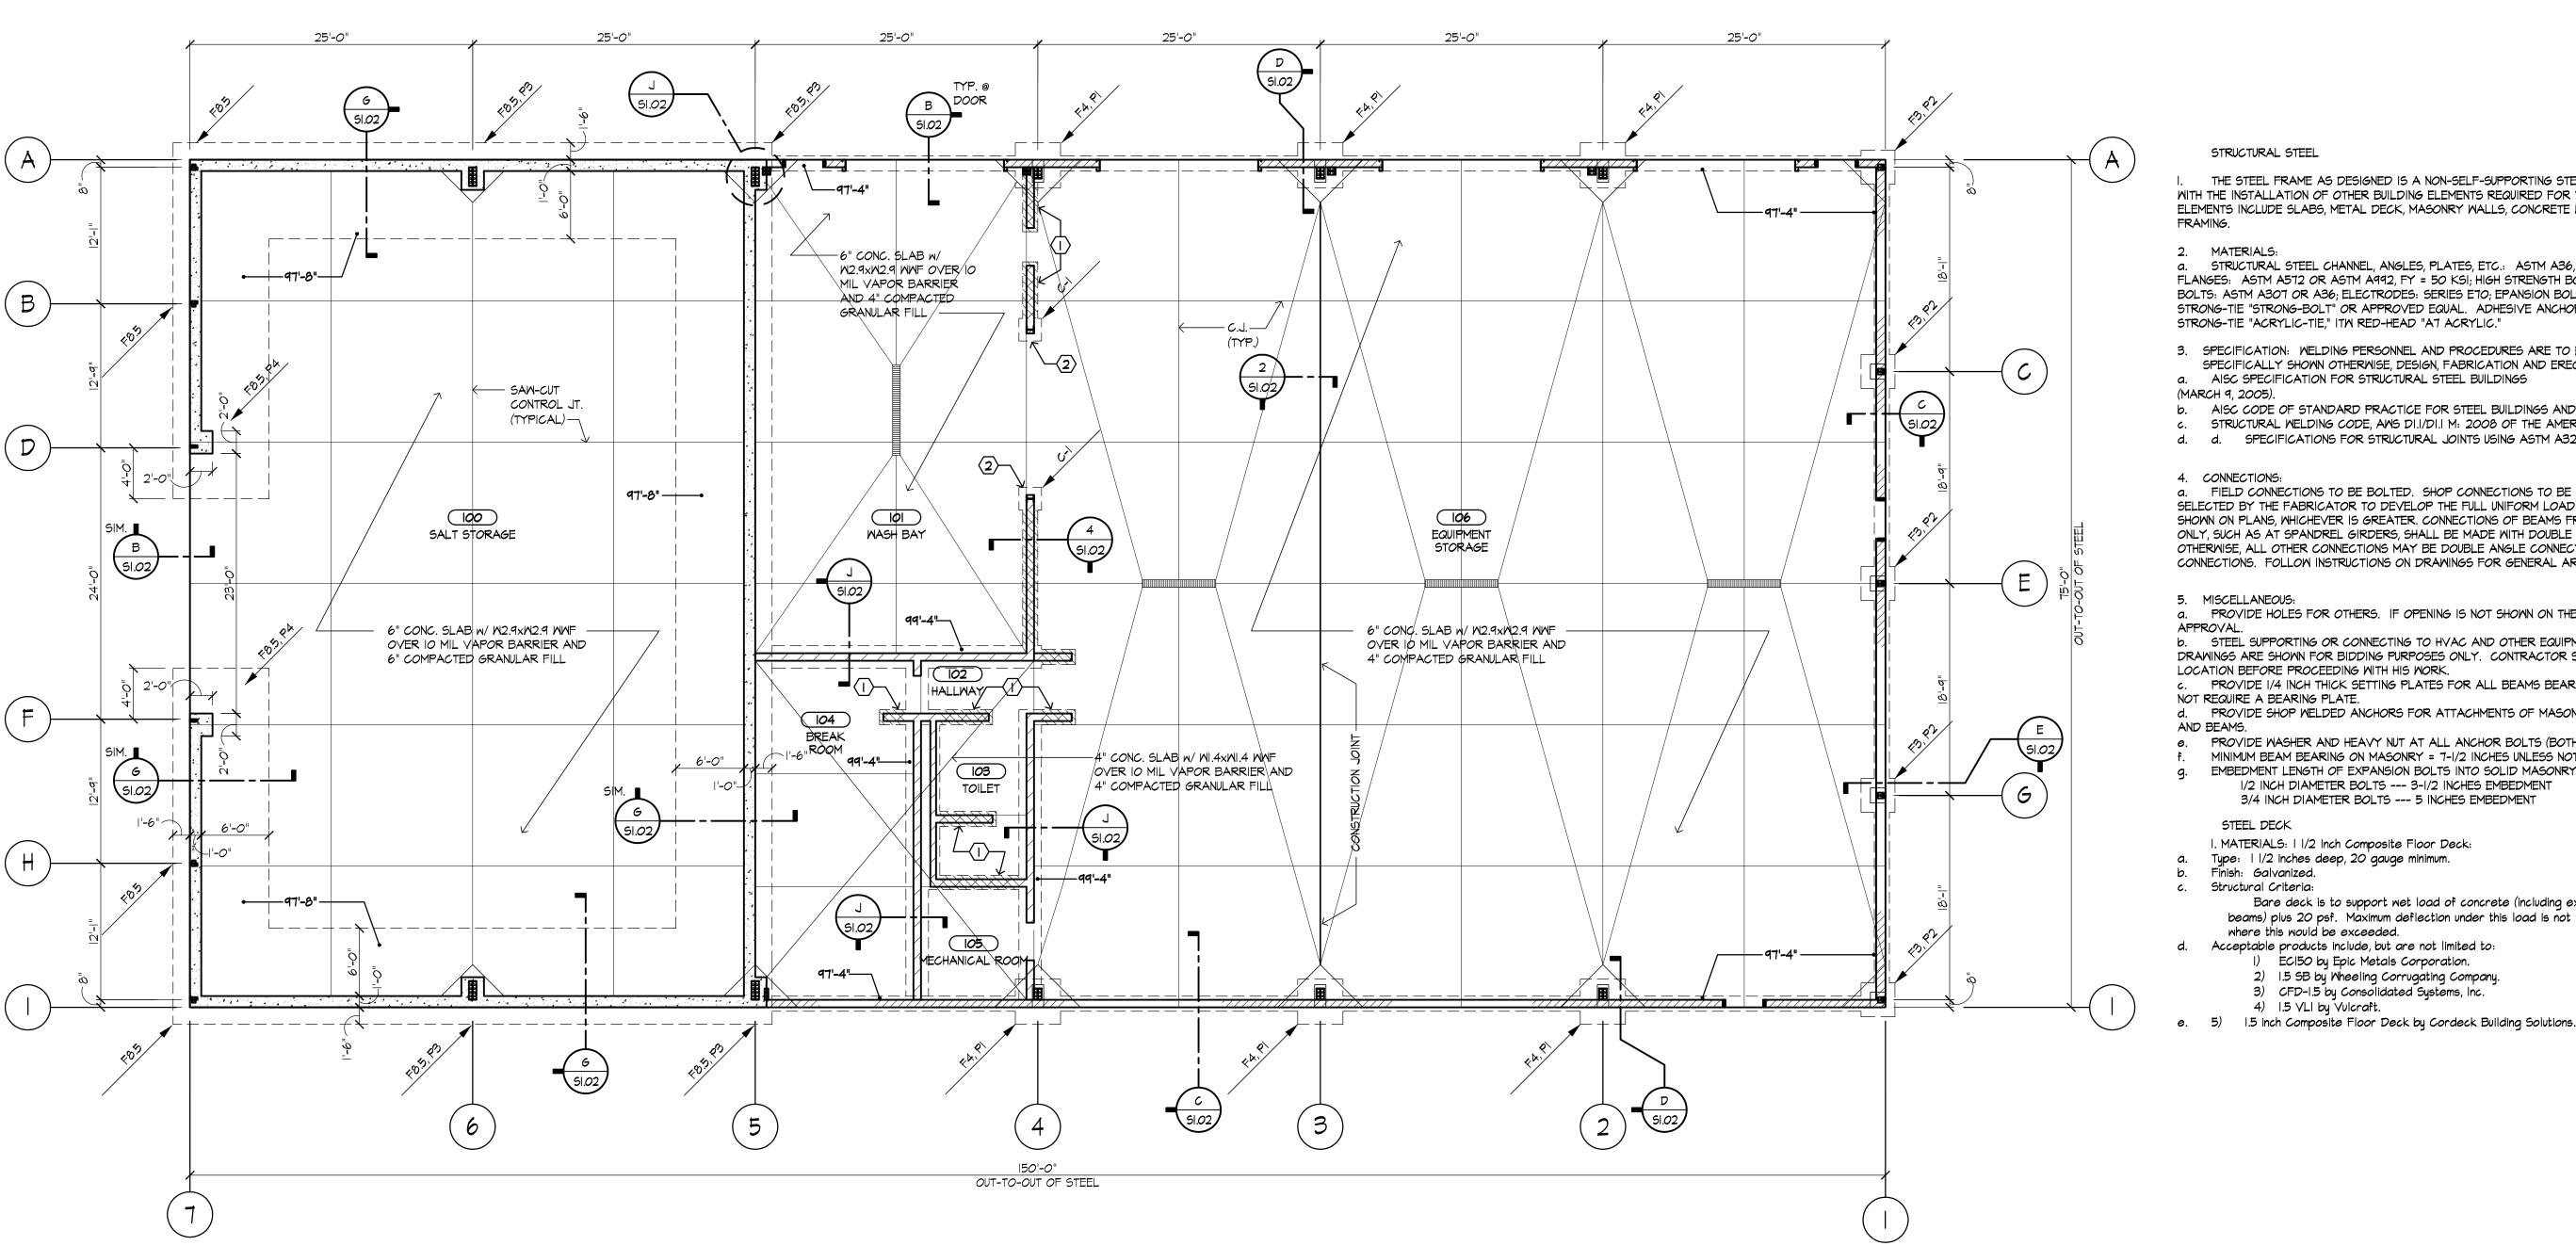

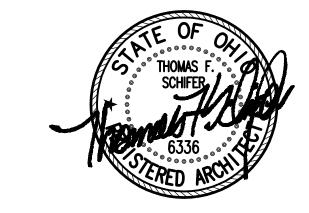

STRUCTURAL STEEL

THE STEEL FRAME AS DESIGNED IS A NON-SELF-SUPPORTING STEEL FRAME. COORDINATE THE ERECTION WITH THE INSTALLATION OF OTHER BUILDING ELEMENTS REQUIRED FOR THE STRUCTURE'S STABILITY. THESE ELEMENTS INCLUDE SLABS, METAL DECK, MASONRY WALLS, CONCRETE WALLS AND LIGHT GAGE METAL

MATERIALS:

STRUCTURAL STEEL CHANNEL, ANGLES, PLATES, ETC.: ASTM A36, FY = 36 KSI; STRUCTURAL STEEL WIDE FLANGES: ASTM A572 OR ASTM A992, FY = 50 KSI; HIGH STRENGTH BOLTS: ASTM A325 OR A490; ANCHOR BOLTS: ASTM A307 OR A36; ELECTRODES: SERIES E70; EPANSION BOLTS: HILTI "KWIK-BOLT TZ," SIMPSON STRONG-TIE "STRONG-BOLT" OR APPROVED EQUAL. ADHESIVE ANCHORS: HILTI "HIT-ICE/HIT HY 150," SIMPSON STRONG-TIE "ACRYLIC-TIE," ITW RED-HEAD "AT ACRYLIC."

- 3. SPECIFICATION: WELDING PERSONNEL AND PROCEDURES ARE TO BE QUALIFIED PER AWS DI.I. UNLESS SPECIFICALLY SHOWN OTHERWISE, DESIGN, FABRICATION AND ERECTION TO BE GOVERNED BY: a. AISC SPECIFICATION FOR STRUCTURAL STEEL BUILDINGS
- AISC CODE OF STANDARD PRACTICE FOR STEEL BUILDINGS AND BRIDGES (MARCH 18, 2005). STRUCTURAL WELDING CODE, AWS DI.I/DI.I M: 2008 OF THE AMERICAN WELDING SOCIETY.
- d. SPECIFICATIONS FOR STRUCTURAL JOINTS USING ASTM A325 OR A490 BOLTS (JUNE 30, 2004).

4. CONNECTIONS:

a. FIELD CONNECTIONS TO BE BOLTED. SHOP CONNECTIONS TO BE WELDED OR BOLTED. CONNECTIONS TO BE SELECTED BY THE FABRICATOR TO DEVELOP THE FULL UNIFORM LOAD CAPACITY OF THE MEMBER OR FORCES SHOWN ON PLANS, WHICHEVER IS GREATER. CONNECTIONS OF BEAMS FRAMING INTO A GIRDER FROM ONE SIDE ONLY, SUCH AS AT SPANDREL GIRDERS, SHALL BE MADE WITH DOUBLE ANGLE CONNECTIONS. UNLESS INDICATED OTHERWISE, ALL OTHER CONNECTIONS MAY BE DOUBLE ANGLE CONNECTIONS OR SINGLE PLATE SHEAR CONNECTIONS. FOLLOW INSTRUCTIONS ON DRAWINGS FOR GENERAL ARRANGEMENT OR PARTICULAR DETAILS.

5. MISCELLANEOUS:

a. PROVIDE HOLES FOR OTHERS. IF OPENING IS NOT SHOWN ON THE STRUCTURAL DRAWINGS, OBTAIN PRIOR

b. STEEL SUPPORTING OR CONNECTING TO HVAC AND OTHER EQUIPMENT AND ROOF OPENINGS AS SHOWN ON DRAWINGS ARE SHOWN FOR BIDDING PURPOSES ONLY. CONTRACTOR SHALL COORDINATE EXACT SIZE AND LOCATION BEFORE PROCEEDING WITH HIS WORK.

c. PROVIDE 1/4 INCH THICK SETTING PLATES FOR ALL BEAMS BEARING ON MASONRY OR CONCRETE WHICH DO NOT REQUIRE A BEARING PLATE.

d. PROVIDE SHOP WELDED ANCHORS FOR ATTACHMENTS OF MASONRY. SPACING TO BE 16 INCHES ON COLUMNS

PROVIDE WASHER AND HEAVY NUT AT ALL ANCHOR BOLTS (BOTH ENDS).

MINIMUM BEAM BEARING ON MASONRY = 7-1/2 INCHES UNLESS NOTED OTHERWISE. EMBEDMENT LENGTH OF EXPANSION BOLTS INTO SOLID MASONRY OR CONCRETE SHALL BE AS FOLLOWS: 1/2 INCH DIAMETER BOLTS --- 3-1/2 INCHES EMBEDMENT 3/4 INCH DIAMETER BOLTS --- 5 INCHES EMBEDMENT

STEEL DECK

1. MATERIALS: 1 1/2 Inch Composite Floor Deck:

Tupe: 1 1/2 inches deep, 20 gauge minimum.

Finish: Galvanized. c. Structural Criteria:

Bare deck is to support wet load of concrete (including excess due to deflection of deck and beams) plus 20 psf. Maximum deflection under this load is not to exceed L/180. Increase gage of deck where this would be exceeded.

d. Acceptable products include, but are not limited to: EC150 by Epic Metals Corporation.

2) 1.5 SB by Wheeling Corrugating Company.

3) CFD-1.5 by Consolidated Systems, Inc. 4) 1.5 VLI by Vulcraft.

JONES

Our Marion Office... 355 East Center Street Suite 200 Marion, Ohio 43302 Phone: (740) 382-6840 Fax: (740) 387-0318

Our Columbus Office..

E-mail: marion@jjsa.net

At Quarry Place 6209 Riverside Drive Suite 200 Dublin, Ohio 43017 Phone: (614) 761-1707 Fax: (614) 761-3996 E-mail: dublin@jjsa.net

(c) 2007 by JESTER JONES SCHIFER ARCHITECTS, LTD. (c) 2007 by JESTER JONES SCHIFER ARCHITECTS, LTD.

THIS DRAWING AND SUBJECT MATTER THEREON,
AS MELL AS THE ASSOCIATED SPECIFICATIONS,
CONSTITUTE THE ORIGINAL AND UNPUBLISHED
WORK OF, AND ARE THE INSTRUMENTS OF SERVICE OF, JESTER JONES SCHIFER ARCHITECTS,
LTD. (JUSA) FOR USE SOLIE! WITH RESPECT TO
THIS PROJECT. THESE INSTRUMENTS REMAIN THE
EXCLUSIVE PROPERTY OF JUSA WHO SHALL
RETAIN ALL COMMON LAM, STATITORY AND
OTHER RESERVED RIGHTS, INCLUDING THE
COPYRIGHT THERETO, AND MAY NOT BE USED,
REPRODUCED, COPIED, OR ALTERED, IN WHOLE
OR PART, FOR ANY DIRFOSE OR POLECT
WITHOUT THE WRITTEN CONSENT OF JUSA.

.

Building

Salt GreenKeeper

. 08590 000 September 18, 2008 DRAWN BY jet CHECKED BY: tfs

.

REVISIONS REV: DATE:


Structural Member Schedule

2 OVERHEAD DOOR JAMB, WOXIS 12"x12"x3/4" BASE PLATE. BEAR ON 24"x24"x12" THICK PAD AND FRAME TO BUILDING

New Work Notes

Mark Section Bearing Elev. W8X13 3/4"x12"x12" Base Plate w/ (2) 3/4"x16" Lg. Anchor Bolts, Frame to Building Ridge Frame Above w/ ∠4x4x1/4" Clip Angle MBXIB Bear East End On Concrete Masonry and 1/4"x7"x12" Bearing Plate and Anchor to Masonry w/ (2) 3/4"XI2" $\tilde{A.B.}$ Bear West End On 1/4"x5"xI2" Bearing Plate In Beam Pocket. Anchor Bearing Plate In Concrete Wall w/ (2) 3/4"XI2" A.B. (2)∠5"x3 l/2"x5/l6" 107'-4" Minimum 4" Bearing Each End




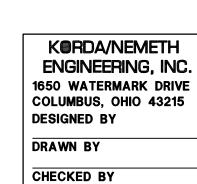


JOB FILE 2008-1003

(I) THICKENED SLAB, SEE DETAIL 4/SI.02

RIGID FRAME ABOVE, SEE DETAILS E/A5.02 AND C/AI.02 (3) BEAR WOXIO IN BEAM POCKET, SEE DETAIL A/SI.OI TYPICAL OF 5.

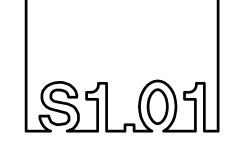

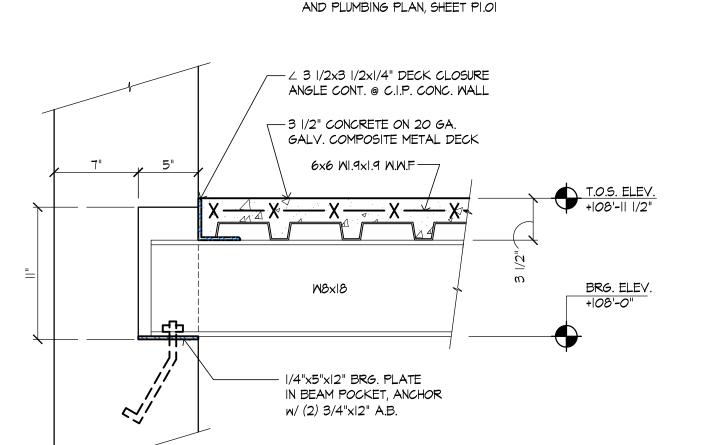

Foundation Plan

UNLESS NOTED OTHER WISE.


INDICATES TRENCH DRAIN, SLOPE SLAB TO

INDICATES THICKENED SLAB, SEE DETAIL 4/SI.02


- 97'-4" INDICATES TOP OF FOOTING ELEVATION. TOP OF FOOTING AND COLUMN PAD ELEVATION IS 97'-4"


DRAIN, SEE SHEET ALOI FOR GRADE ELEVATIONS

| |/2"=|'-0"

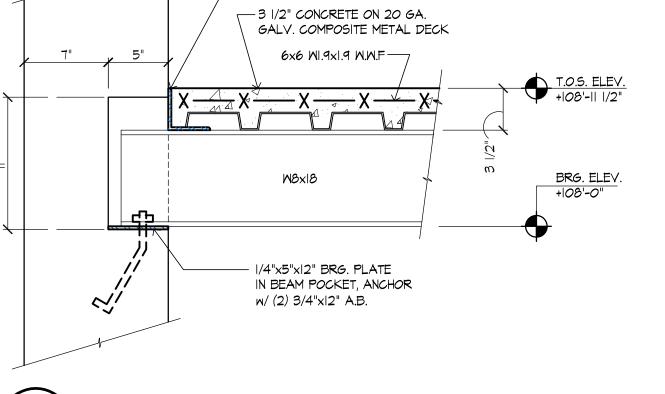

Beam Pocket

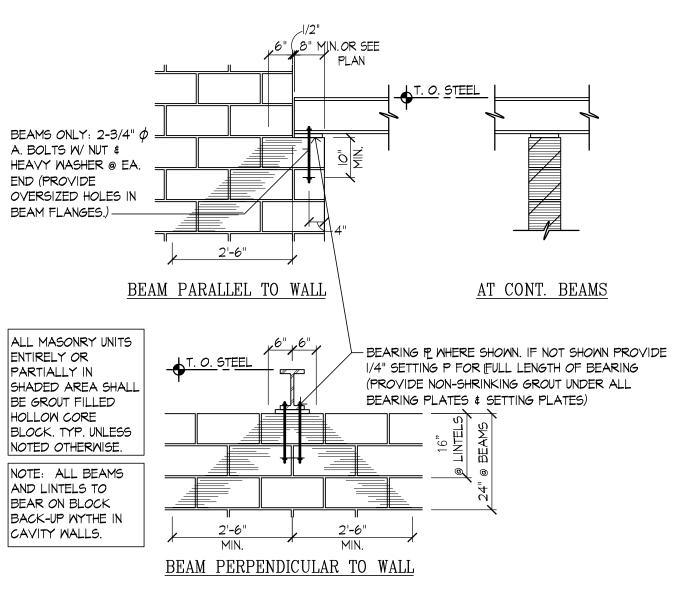

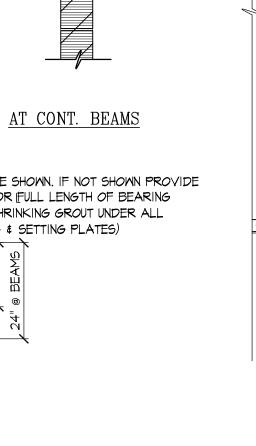

7 1/2" BEARING ON

Mezzanine Framing Plan

1/2×7-1/2×7-1/2 BRG.

PE TYPICAL THIS

/---//


SI.01

-5 1/2" BEARING ON

PL TYPICAL THIS

1/2x5-1/2x7-1/2 BRG.


Section: Masonry Bearing 1/2"=1'-0"

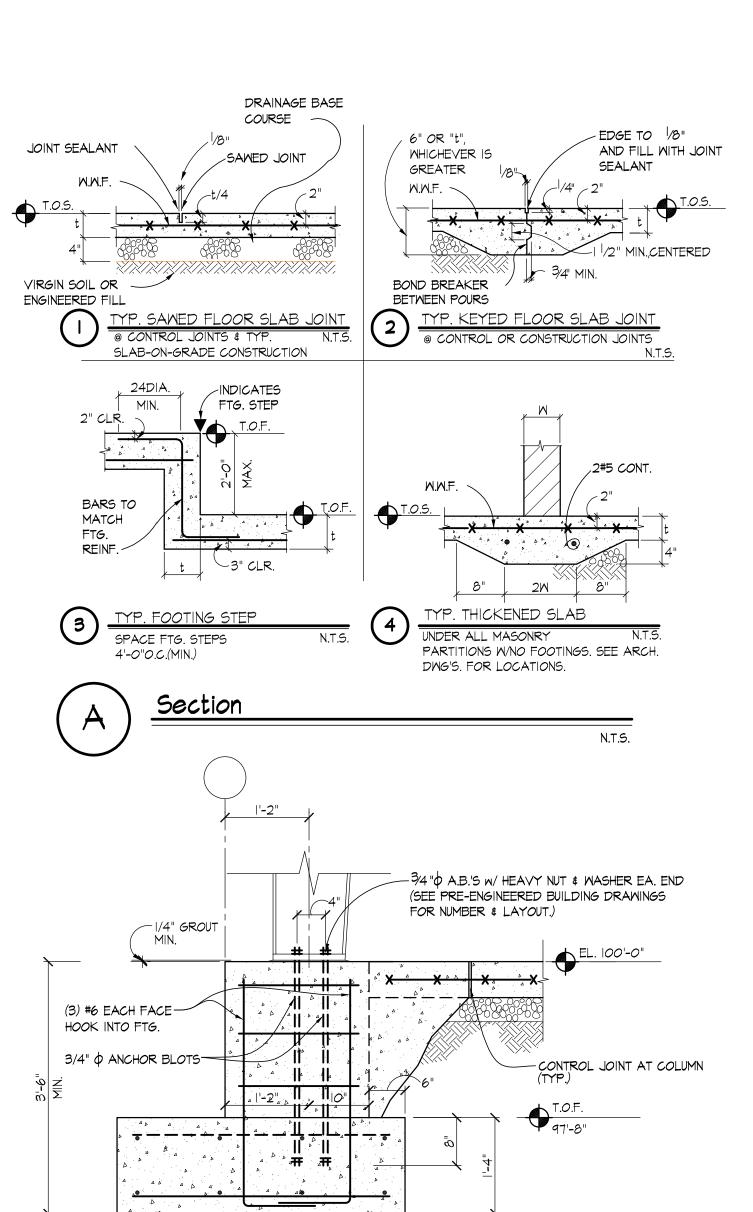


WAY TOP & BOTTOM PIER CAST W/ SLAB, SAW CUT CONTROL JOINT AROUND PIER 3/4"=1'-0" SEE SHEET SI.OI


W/ (4) # 5 EACH


F	OOTING S	CHEDUL	E (25	00 PSI	= 5	SOIL)
MARK	SIZE			BOTTOM NFORCEMENT		REMARKS
F3	3'-0"x3'-0"x12" T	THK.	(4) #4 EA	. WAY TOP \$ BOTT	SEE DETAIL E/SI.02	
F4.0	4'-0"x4'-0"x 6" T	THK.	5#5 E	.W., TOP & BOTTOM	SEE DETAIL D/SI.02	
F8.5	CONT. x 18" THK.	#9 @ 12" O.C. w/(9) #5 PERPENDICULAR, CONTINUOUS SEE DETAIL G/S				
		PIER S	SCHEI	DULE		
MARK	SIZE	VERT. RI	EINF.	TIES		PIER TYPE
PI	l2"X24"	(4)#6		#3@ 2"	ı	
P2	16"X16"	(4)#6		#3@ 2"	П	
P3	24"X32"	(4)#6 VERT. E	A. FACE	#3@ 2"	SEE DETAIL H/SI.O2	
P4	24"X24"	(3)#6 VERT. E.	A. FACE	#3@ 2"	(PIER P4 TO EXTEND TO EL. 112'-0" A.F.F

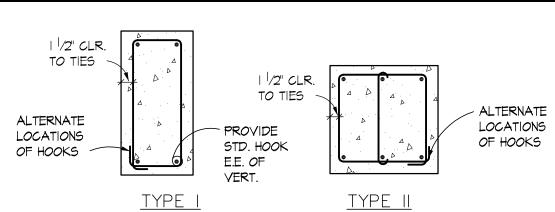



3/4"=1'-0"

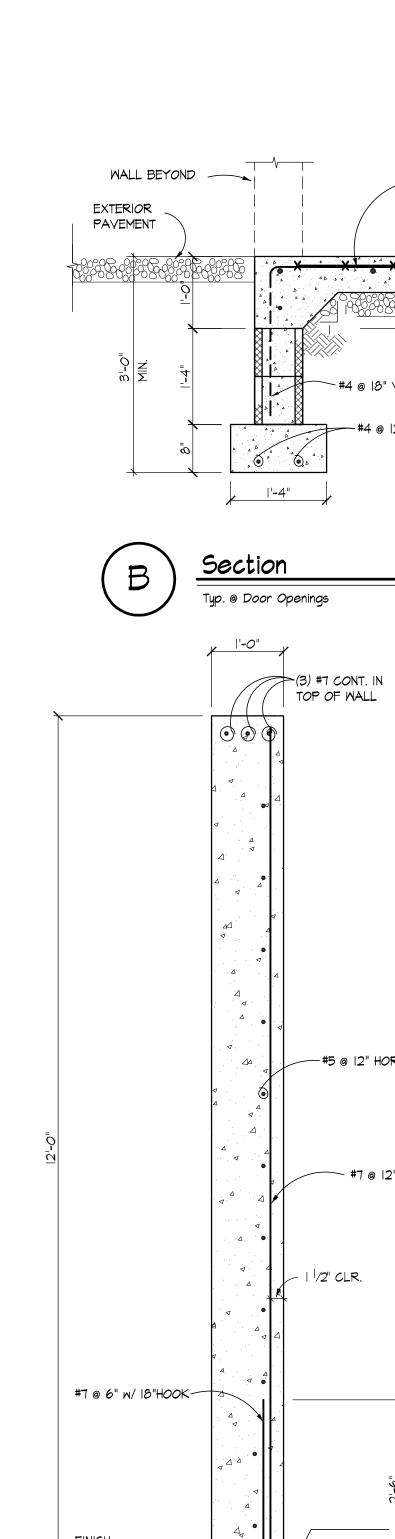

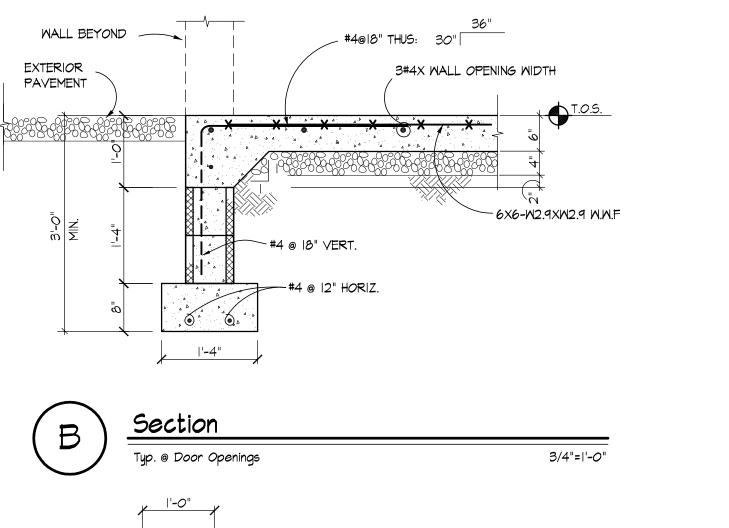


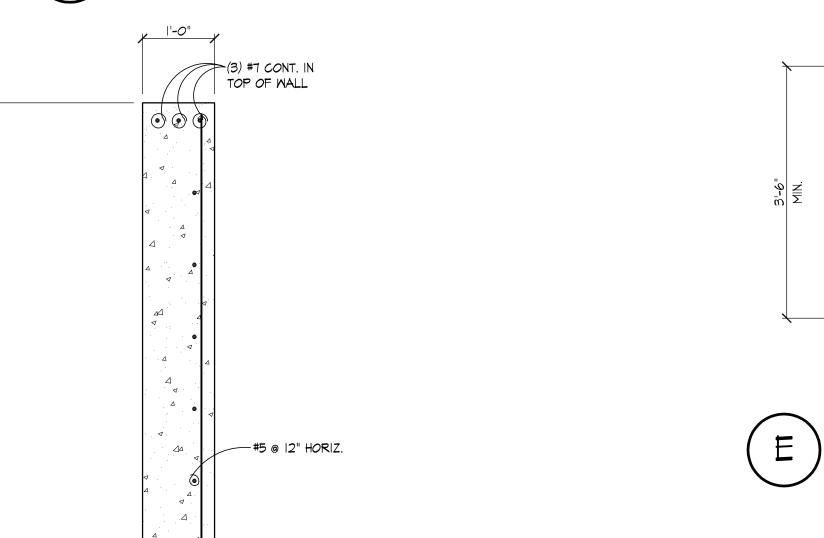

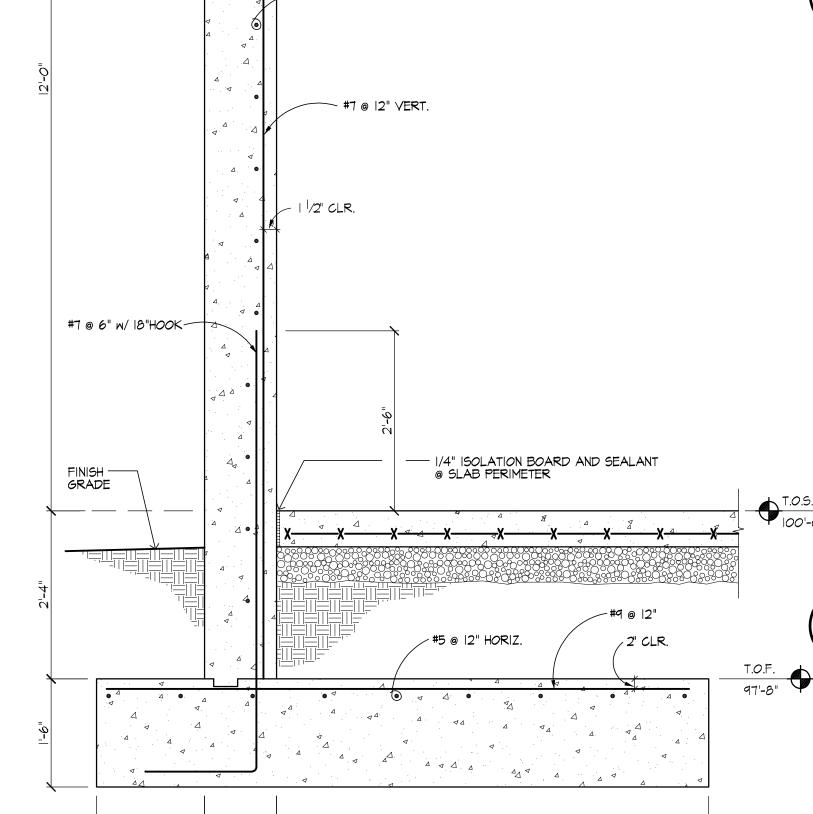


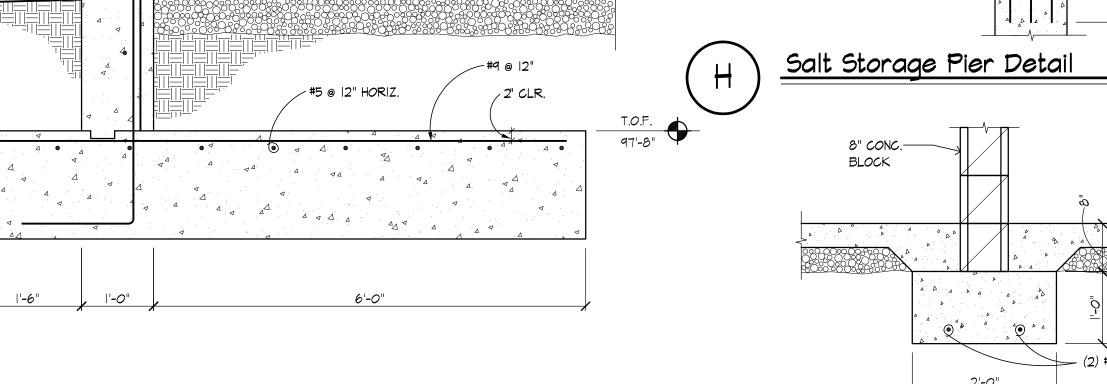


Typical Salt Storage Wall 3/4"=1'-0"

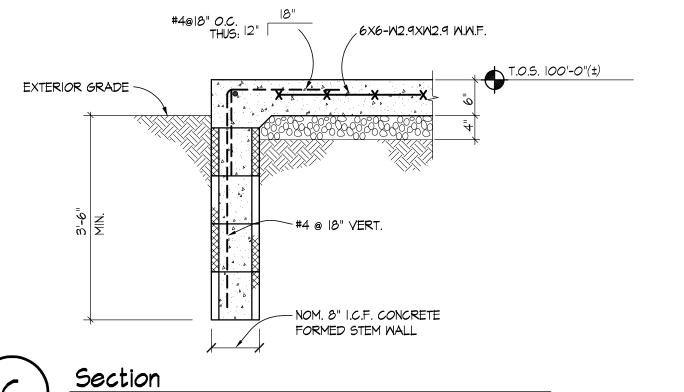


3/4"=1'-0"

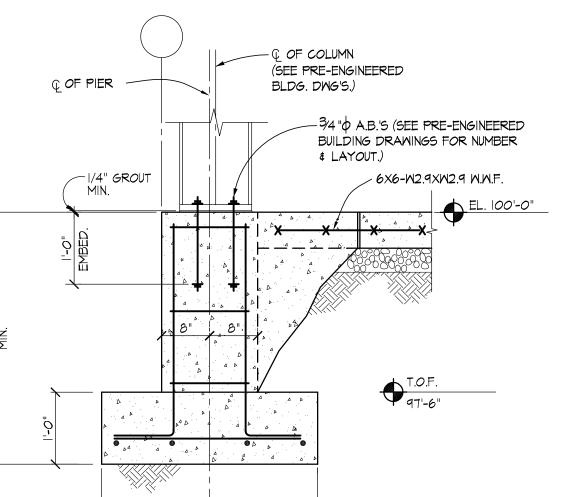

Section PIER CAST W/ SLAB, SAW CUT CONTROL JOINT AROUND PIER 3/4"=1'**-**0" SEE SHEET SI.OI

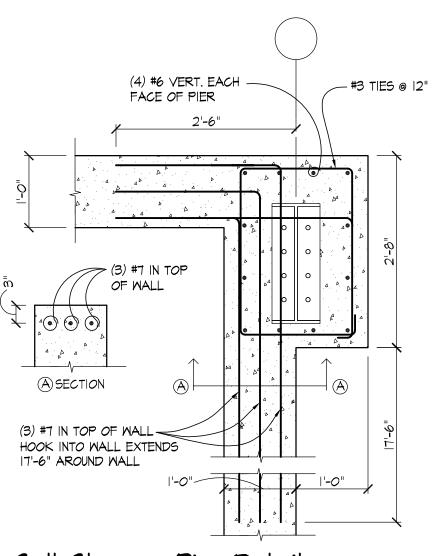

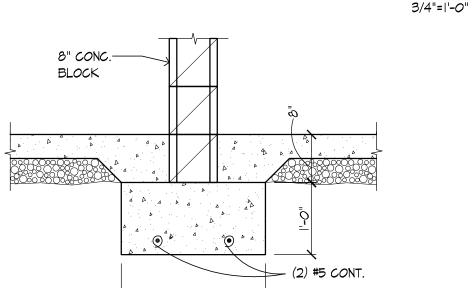

Salt Storage Pier Detail

COLUMBUS, OHIO 43215 DESIGNED BY 3/4"=1'-0"

> CHECKED BY JOB FILE 2008-1003

KORDA/NEMETH

ENGINEERING, INC. 1650 WATERMARK DRIVE

A. REINFORCED CONCRETE

I. MATERIALS: a. SPECIFICATIONS: IN GENERAL, COMPLY WITH ACI 301-05 "SPECIFICATIONS FOR STRUCTURAL CONCRETE FOR BUILDINGS."

b. STRUCTURAL CONCRETE CLASS LOCATION F'C I FOOTINGS.

> INTERIOR SLABS ON GRADE, 3500 AND ALL INTERIOR CONCRETE NOT OTHERWISE IDENTIFIED.

III WALLS, PIERS, AND COLUMNS, 4000 W/5% 1-1/2% EXTERIOR SLABS ON GRADE ENTRAINED AIR AND ALL EXTERIOR CONCRETE NOT OTHERWISE IDENTIFIED.

IV BACKFILL BELOW FOOTINGS

c. ALL DEFORMED REINFORCING BARS: FY = 60,000

2. FIELD MANUAL: PROVIDE AT LEAST ONE COPY OF THE ACI FIELD REFERENCE MANUAL, SP-15, IN THE FIELD OFFICE AT ALL TIMES.

3. CONTINGENCIES: a. PROVIDE SUPPORTS AS REQUIRED TO MAINTAIN ALIGNMENT OF SCHEDULED

REINFORCING.

4. FOOTINGS, COLUMNS:

a. DOWELS IN FOOTINGS TO MATCH VERTICAL COLUMN OR PIER REINFORCING.

b. BACKFILL AGAINST BOTH SIDES OF WALLS EQUALLY UNTIL THE LOWER ELEVATION IS ATTAINED.

c. PROVIDE LEAN CONCRETE (CLASS IV) UNDER FOUNDATIONS FOR ACCIDENTAL OVER-EXCAVATION, SOFT SPOTS AND TRENCHES.

5. SPLICES: UNLESS NOTED OTHERWISE, MINIMUM LAP SPLICE LENGTHS TO BE AS FOLLOWS:

a. VERTICAL BARS IN PIERS, 45 DIAMETERS OR COLUMNS (INCLUDING DOWELS) b. HORIZONTAL BARS IN SLABS &

35 DIAMETERS FOOTINGS c. HORIZONTAL BARS IN WALLS 45 DIAMETERS 6. CONSTRUCTION JOINTS:

a. CONSTRUCTION JOINTS PERMITTED ONLY WHERE SHOWN OR AS APPROVED BY THE STRUCTURAL ENGINEER. ALL CONSTRUCTION JOINTS ARE TO BE KEYED. KEYWAYS SHALL BE 1-1/2 INCHES DEEP X 1/3 MEMBER THICKNESS.

7. CONCRETE COVER: UNLESS NOTED OTHERWISE, DETAIL REINFORCING TO PROVIDE CONCRETE COVER AS FOLLOWS:

a. CONCRETE CAST AGAINST AND PERMANENTLY EXPOSED TO EARTH: 3 INCHES b. CONCRETE EXPOSED TO EARTH OR

MEATHER: #5 BARS AND SMALLER 1-1/2 INCHES OTHERS 2 INCHES

8. MISCELLANEOUS:

a. GROUT UNDER BEARING PLATES, SETTING PLATES, AND COLUMN BASE PLATES SHALL BE NON-SHRINKING TYPE. THE USE OF LEVELING PLATES AT COLUMN BASES IS PROHIBITED. GROUT BELOW BEARING PLATES, SETTING PLATES, AND COLUMN BASE PLATES IS TO BE INSTALLED ONLY AFTER THE STEEL IS PLUMBED.

FOUNDATION NOTES

REFERENCE ELEVATION 100'-0".

2. FOOTINGS SHALL BE FOUNDED ON VIRGIN SOIL OR ON ENGINEERED FILL AT THE ELEVATIONS SHOWN WITH A DESIGN BEARING CAPACITY OF 2.5 KSF. ALL FOOTING EXCAVATIONS SHALL BE INSPECTED AND APPROVED BY THE OWNER'S SOILS ENGINEER FOR THE BEARING CAPACITY INDICATED ABOVE PRIOR TO PLACING CONCRETE.

3. KEEP FOUNDATION EXCAVATIONS FREE OF WATER AT ALL TIMES. REPLACE SOFT OR WEAKENED SOIL WITH CLASS IV CONCRETE.

4. ELEVATIONS SHOWN AT FOOTINGS ARE TOP OF FOOTING ELEVATION (T.O.F.).

5. ALL EXTERIOR FOOTINGS TO BEAR MIN. 3'-O" BELOW ADJACENT GRADE. ADJUST BOTTOM OF FOOTING AS REQUIRED.

6. ALL T.O.F. = 97'-4", U.N.O.

7. TOP OF PIER ELEVATION (T.O.P.) = 100'-0", U.N.O.

8. FLOOR CONSTRUCTION = 6" THICK CONCRETE SLAB ON GRADE REINFORCED WITH 6X6XM2.9XM2.9 M.M.F., U.N.O. SEE DETAIL A/S2 FOR TYPICAL CONCRETE SLAB-ON-GRADE CONSTRUCTION.

9. TOP OF SLAB EL. (T.O.S.) = 100'-0", U.N.O. SEE ARCHITECTURAL AND MECHANICAL DRAWINGS FOR MINOR DEPRESSIONS AND SLOPES TO DRAINS.

10. PROVIDE THICKENED SLAB PER DETAIL A/S2 UNDER ALL CMU WALLS WHICH ARE NOT ON FOOTINGS. SEE ARCHITECTURAL DRAWINGS FOR LOCATION.


II. SEE SHEET SI.02 FOR FOOTING AND PIER SCHEDULES.

12. SEE SHEET SI.02 FOR CONCRETE NOTES.

13. CANTILEVERED RETAINING WALLS HAVE BEEN DESIGNED FOR AN EQUIVALENT LATERAL FLUID PRESSURE OF 60 PCF.

14. BACKFILL AGAINST ALL RETAINING WALLS SHALL CONSIST OF FREE-DRAINING GRANULAR MATERIAL FOR FULL HEIGHT OF THE WALL. MINIMUM THICKNESS OF GRANULAR MATERIAL SHALL BE 2'-0".

15. ▼INDICATES FOOTING STEP. SEE A.3/SI.02

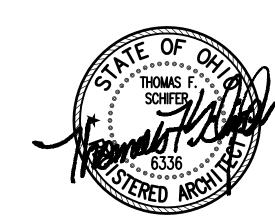

JESTER JONES

Our Marion Office... 355 East Center Street Suite 200 Marion, Ohio 43302 Phone: (740) 382-6840 Fax: (740) 387-0318 E-mail: marion@jjsa.net

Our Columbus Office.. At Quarry Place 6209 Riverside Drive Suite 200 Dublin, Ohio 43017 Phone: (614) 761-1707

Fax: (614) 761-3996 E-mail: dublin@jjsa.net (c) 2001 by JESTER JONES SCHIFER ARCHITECTS, LTD. (c) 2007 by JESTER JONES SCHIFER ARCHITECTS, LTD.

THIS DRAWING AND SUBJECT MATTER THEREON,
AS MELL AS THE ASSOCIATED SPECIFICATIONS,
CONSTITUTE THE ORIGINAL AND UNPUBLISHED
WORK OF, AND ARE THE INSTRUMENTS OF SERVICE OF, JESTER JONES SCHIFER ARCHITECTS,
LTD. (JUSA) FOR USE SOLIE! WITH RESPECT TO
THIS PROJECT. THESE INSTRUMENTS REMAIN THE
EXCLUSIVE PROPERTY OF JUSA WHO SHALL
RETAIN ALL COMMON LAM, STATITORY AND
OTHER RESERVED RIGHTS, INCLUDING THE
COPYRIGHT THERETO, AND MAY NOT BE USED,
REPRODUCED, COPIED, OR ALTERED, IN WHOLE
OR PART, FOR ANY DIRFOSE OR POLECT
WITHOUT THE WRITTEN CONSENT OF JUSA.

.


#2 Building

GreenKeeper

. 08590 000 September 18, 2008 DRAWN BY jet CHECKED BY: tfs REVISIONS

REV: DATE:



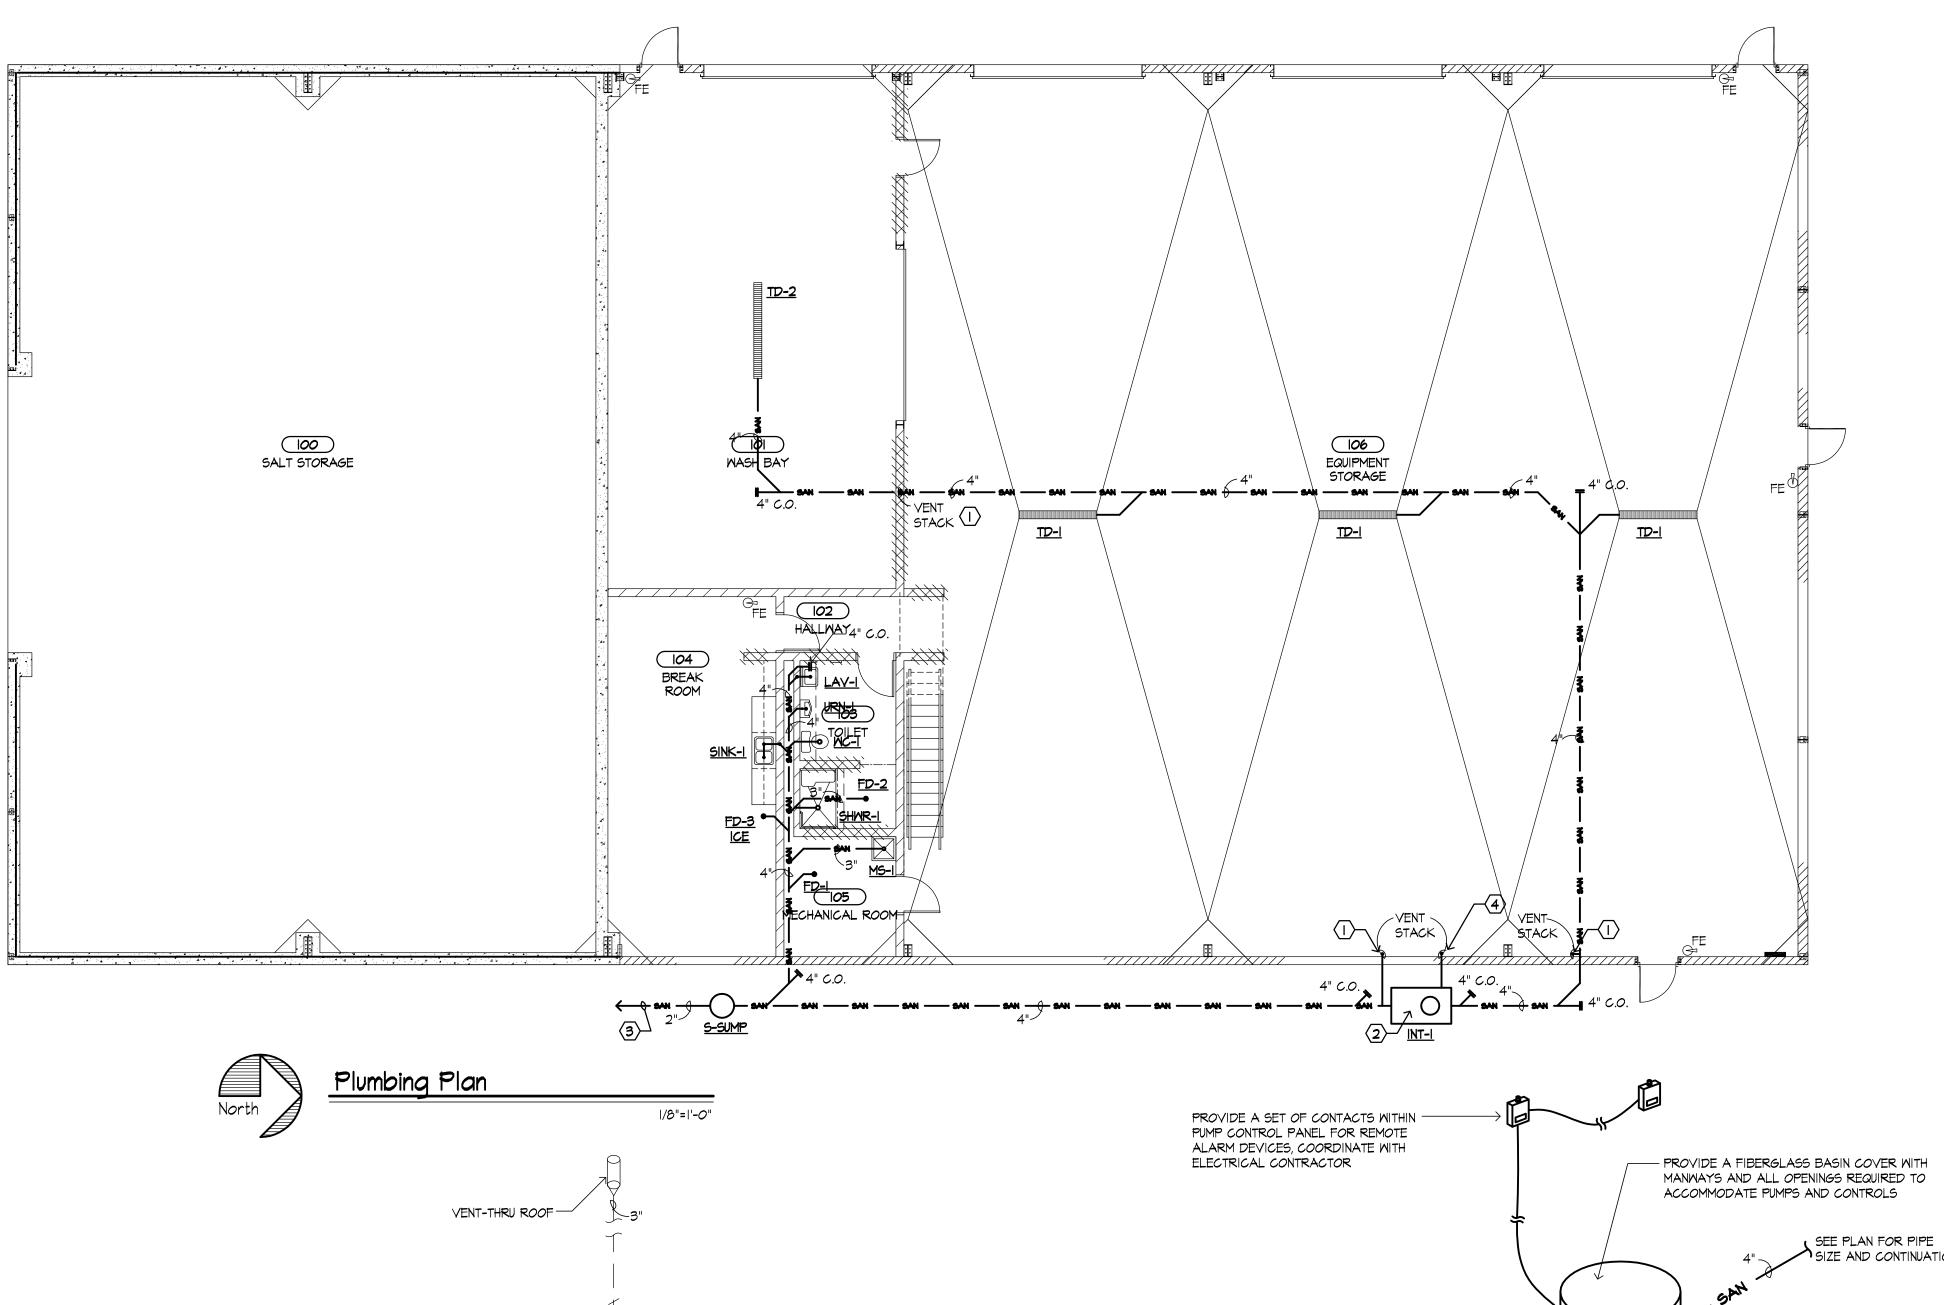

VENT-THRU ROOF

4" C.O.─

VENT-THRU ROOF -

1 1/2"


N.T.S.

4" C.O.—

S-SUMP

Stack Diagram

EXTEND BELOW GRADE TO EXIST. SEPTIC SYSTEM

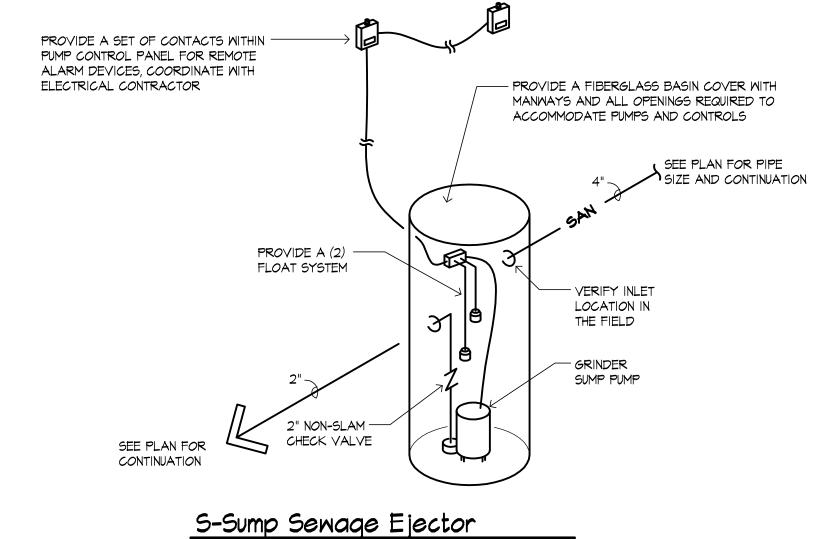

General Plumbing Notes

- ALL NEW WORK SHALL CONFORM TO CURRENT OHIO BUILDING CODE, NATIONAL PLUMBING CODE, OHIO SANITARY CODE, COUNTY BOARD OF HEALTH REGULATIONS, AND ANY OTHER APPLICABLE CODES OR REQUIREMENTS. PLUMBING CONTRACTOR SHALL VERIFY ALL EXISTING UTILITIES, ACQUIRE AND PAY FOR ALL PERMITS, CERTIFICATES, AND INSPECTIONS, AND PERFORM ALL WORK FOR INSTALLATION OF GAS, WATER, AND SEWER
- COORDINATE ALL WORK WITH OTHER TRADES THROUGH THE GENERAL CONTRACTOR, AND NOTIFY THE ARCHITECT OF ANY MAJOR INSTALLATION CHANGES.
- PROVIDE STEEL SLEEVES WHERE PIPE PENETRATES MASONRY, AND PACK SLEEVES AT COMPLETION OF WORK. COPPER PIPING PENETRATING POURED-IN-PLACE CONCRETE SHALL BE WRAPPED IN ARMAFLEX AT ALL
- ALL WASTE AND VENT LINES SHALL BE RUN CONCEALED BELOW SLABS, IN CHASES, WALLS, AND FLOOR/CEILING STRUCTURES EXCEPT AS SPECIFICALLY NOTED AS EXPOSED PIPING.
- TAG ALL VALVES FOR DOMESTIC COLD WATER, DOMESTIC HOT WATER, AND DOMESTIC HOT WATER RETURN, AND SPRINKLER LINES.
- PLUMBING FIXTURES AND TRIM SHOWN ON THE DRAWINGS SHALL BE AS NOTED ON THE FIXTURE SCHEDULE; CUT-SHEETS WITH COLOR CHART SHALL BE SUBMITTED TO THE OWNER FOR APPROVAL.
- ALL FLOOR DRAINS IN CONCRETE SHALL BE SET I" BELOW SLAB LEVEL. CONCRETE CONTRACTOR SHALL SLOPE FLOOR TO DRAINS.
- ALL HOT AND COLD WATER SUPPLY LINES, AND ALL WASTE AND VENT LINES SHALL BE RUN CONCEALED IN CHASES OR WALLS PROVIDED EXCEPT AS SPECIFICALLY NOTED AS EXPOSED PIPING.
- WRAP ALL EXPOSED HOT AND COLD WATER LINES W/ MIN. 1/2" ARMAFLEX PIPE INSULATION AND TAPE ALL JOINTS.
- PROVIDE UNIONS AND UPSTREAM SHUT-OFF VALVE AT PUMPS, WATER HEATERS, WATER METERS, AND OTHER ITEMS OF EQUIPMENT WHICH CAN BE REMOVED OR REPLACED.
- REFER TO ARCHITECTURAL DRAWINGS FOR ADDITIONAL SCOPE/INFORMATION.

Plumbing Fixture Schedule:

NOTE: OWNER TO SELECT THE FIXTURE COLOR FROM THE MANUFACTURER'S FULL COLOR PALETTE. ALL TRIM UNLESS OTHERWISE

Mark	Manufacturer	Description	Pipe CM	HM
<u>INT-I</u>	NORWALK CONCRETE INDUSTRIES	OIL AND SEDIMENT INTERCEPTOR, MINIMUM 500 GALLON CAPACITY AS MANUFACTURED BY NORWALK CONCRETE INDUSTRIES. 4" DIA. INLET/OUTLET. INSTALL TOP FLUSH WITH EXTERIOR GRADE. PRE-CAST CONSTRUCTION WITH CAST-IRON LID AND FRAME. EQUIPMENT AS ABOVE OR APPROVED EQUAL AS SELECTED BY OWNER. PROVIDE WITH INTERNAL BAFFLE FOR SEDIMENT SEPARATION.		
<u>NO-1</u>	AMERICAN STANDARD /BEMIS	FLOOR MOUNTED TANK TYPE WATER CLOSET. AMERICAN STANDARD MODEL NUMBER 2998.012 CADET II, SIPHON JET ACTION, CLOSE COUPLED TANK, I.6 MAX. GALLON PER FLUSH, I6 I/8" RIM HEIGHT, VITREOUS CHINA, ELONGATED BOWL, & CHROME FLUSH ARM. BEMIS MODEL 1655-SSC, OPEN FRONT SEAT, SELF SUSTAINING STAINLESS STEEL CHECK HINGES. PROVIDE WITH WAX RING, CLOSET ELBOW, FLOOR FLANGE, CHROME PLATED SUPPLY RISER, AND CHROME PLATED KEY-OPERATED STOP. INSTALLATION TO COMPLY WITH ADA REQUIREMENTS.	1/2"	
<u>LAV-I</u>	AMERICAN STANDARD/ ZURN/ MCGUIRE	WALL HUNG LAVATORY, AMERICAN STANDARD MODEL 0355.012 LUCERNE, WHITE VITREOUS CHINA, FAUCET LEDGE, D SHAPED BOWL, FRONT OVERFLOW, 4" CENTERSET HOLES, REAR AND SIDE SPLASH SHIELDS. AMERICAN STANDARD MODEL 2385.005 SINGLE HANDLE FAUCET, 4" CENTERSET SUPPLIES, AERATOR, OFFSET GRID STRAINER, CERAMIC DISC VALVE, INDEXED METAL LEVER HANDLE, MODEL 002 POLISHED CHROME FINISH. PROVIDE WITH CHROME PLATED CAST BRASS P-TRAP, CHROME KEY-OPERATED STOPS AND CHROME PLATED SUPPLY RISERS. PROVIDE FLEXIBLE SEAMLESS CLOSED CELL PADDED COVER BELOW LAVATORY SIMILAR TO MCGUIRE PROWRAP. PROVIDE WITH CARRIER SIMILAR TO ZURN SERIES 1200 WITH RECTANGULAR UPRIGHTS. FLOOR MOUNTING BOLTS, SHORT FOOT, AND NEOPRENE GASKET. INSTALLATION TO COMPLY WITH ADA REQUIREMENTS.	1/2"	1/2
<u>MS-I</u>	FIAT/ AMERICAN STANDARD	MOLDED STONE FLOOR MOUNTED SERVICE SINK, FIAT MODEL MSB-2424 24"x24" OVERALL SIZE, PROVIDE WITH FIAT MODEL MSG-2424 STAINLESS STEEL WALL GUARD AND FIAT MODEL E-77-AA CURB CAPS. AMERICAN STANDARD MODEL 8344.II2 EXPOSED WALL MOUNTED FAUCET WITH TOP BRACE, VACUUM BREAKER, ANGLE STOPS, 4 ARM CHROME PLATED METAL LEVER HANDLES, BUCKET HOOK, THREADED HOSE END, CHROME FINISH. PROVIDE CHROME PLATED METAL STRAINER, LINT BASKET AND CAST BRASS P-TRAP.	3/4"	3/4
SHMR-I	AQUAGLASS/ LEONARD	AQUAGLASS MODEL #836336 SINGLE PIECE GELCOAT GLASS FIBER SHOWER STALL ENCLOSURE 62 3/4"x36 3/4"x78" ONE PIECE, FURNISH WITH SELF CAULKING BRASS DRAIN WITH STAINLESS STEEL STRAINER. FACTORY INSTALLED VERTICAL GRAB BAR & FACTORY INSTALLED HORIZONTAL WRAP AROUND GRAB BAR. FACTORY INSTALLED CURTAIN ROD. FACTORY INSTALLED FOLDABLE HANDICAPPED SHOWER SEAT. SHOWER STALL SHALL BE EQUIPPED W/ MODIFIED MAXIMUM I/2" THRESHOLD. PROVIDE LEONARD AQUATROL MODEL 4500 PRESSURE BALANCING VALVE WITH MANUAL VOLUME CONTROL, ADJUSTABLE HIGH TEMPERATURE LIMIT STOP, VANDAL CHECKSTOPS, LEONARD MODEL H-03 BRASS SHOWER HEAD WITH 2.5 GPM MAXIMUM FLOW RATE, LEONARD MODEL D-2L DIVERTER VALVE, LEONARD MODEL 50IP HAND HELD SHOWER, ADJUSTABLE SPRAY WITH 2.5 GPM MAXIMUM FLOW RATE. SHOWER INSTALLATION TO COMPLY WITH ALL APPLICABLE ADA REQUIREMENTS.		
SINK-I	ELKAY	FIXTURE; DOUBLE COMPARTMENT; ELKAY MODEL NO. LR-3322 CONTROLS; ELKAY MODEL NO. LKE-4223 WITH HAND SPRAY, ADA SINGLE LEVER HANDLE MIXING VALVE, CHROME FINISH, II-I/8" SPOUT HEIGHT IO" REACH, SWIVEL 2.2 GPM AERATOR. DRAIN; ELKAY MODEL NO. LK-35 BASKET STRAINER TRAP; McGUIRE MODEL 8912 I/2"x I/2" I7 GA. P-TRAP, CHROME PLATED STOPS; McGUIRE MODEL 2165 I/2" LAVATORY SUPPLIES W/ WHEEL HANDLE BRASS ANGLE STOPS AND COPPER FLEX TUBE RISERS. ALL CHROME PLATED		
<u>9-9UMP</u>	ZOELLER OR MYERS	THE SEWAGE SUMP SHALL BE A TURN KEY PRE-PACKGED AND JOB READY GRINDER SYSTEM. THE SYSTEM SHALL BE SIMILAR TO ZOELLER PUMP CO., INC. ITEM #922-0055, OR MYERS PENTAIR PUMP GROUP, SIMPLEX 24" AND INCLUDE THE FOLLOWING: A. THE GRINDER PUMP SHALL BE SIMILAR TO ZOELLER MODEL #MD820 OR MYERS MRG 20, SUBMERSIBLE TYPE 2HP, GRINDER PUMP, 230 VOLT, I-PHASE. B. FIBERGLASS BASIN TO BE APPROVED/PROVIDED BY THE PUMP MANUFACTURER, 24" DIAMETER x72" DEPTH SIZE OR AS REQUIRED. FURNISH WITH HOLD DOWN FLANGES FOR INTEGRATION INTO CONCRETE ANTI-FLOTATION BASE. FURNISH WITH APPROVED LISTED VENTED SOLID FIBERGLASS BASIN COVER. PAINT BOTH SIDES OF BASIN LID. PACKAGED BASIN ASSEMBLY TO INCLUDE ANTI-FLOATATION DEVICE, I I/4" DISCHARGE PIPING, SQUARE GUIDE RAIL ASSEMBLY CHECK AND BALL VALVES, INLET DISCHARGE AND ELECTRICAL FITTINGS, AND STAINLESS STEEL LIFTING CABLE AND LIFTING ROD. C. CONTROLS SHALL CONSIST OF A PUMP CONTROL FLOAT SWITCH, ALARM PANEL, WATER LEVEL ALARM FLOAT SWITCH TO SIGNAL AUDIO/VISUAL ALARMS. LOCATE ONE ALARM IN THE EMPLOYEE LOUNGE AND ONE IN THE WASH BAY IN EXACT LOCATIONS SPECIFIED BY OWNER.		
<u>FD-I</u>	ZURN	ZURN MODEL NO. ZN-415 CAST IRON FLOOR DRAIN WITH SECONDARY DRAINAGE / ANCHOR FLANGE, WEEPHOLES, ADJUSTABLE FRAME AND GRATE WITH POLISHED NICKEL BRONZE FINISH, 6" DIAMETER ROUND TOP WITH SQUARE OPENINGS AND BOTTOM GASKET CONNECTION OUTLET. DRAINS IN STRUCTURES ABOVE GRADE TO BE FURNISHED WITH CLAMPING COLLAR.		
FD-2	ZURN	ZURN MODEL NO. ZN-610 CAST IRON FLOOR DRAIN WITH SECONDARY DRAINAGE / ANCHOR FLANGE, WEEPHOLES, COATED FRAME AND GRATE, 12" SQUARE TOP WITH SLOTTED OPENINGS, REMOVABLE SEDIMENT BUCKET AND BOTTOM GASKET CONNECTION OUTLET. DRAINS IN STRUCTURES ABOVE GRADE TO BE FURNISHED WITH CLAMPING COLLAR.		
TD-I	ACO USA	ACO POWER DRAIN #SIOOK, INTERLOCKING COMPONENTS W/O.6% BUILT- IN CONTINUOUSLY SLOPED RUN AND HEAVY DUTY SLOTTED IRON GRATING WITH BOLTLESS POWER-LOK LOCKING SYSTEM. FURNISH WITH 4" OUTLET, SOLID END CAPS AND PLUMB WITH 4" SCHED 40 PVC PIPE.		
<u>TD-2</u>	ACO USA	ACO POWER DRAIN #SIOOK, INTERLOCKING COMPONENTS W/O.6% BUILT- IN CONTINUOUSLY SLOPED RUN AND HEAVY DUTY SLOTTED IRON GRATING WITH BOLTLESS POWER-LOK LOCKING SYSTEM. FURNISH WITH 4" OUTLET, SOLID END CAPS AND PLUMB WITH 4" SCHED 40 PVC PIPE.		

Plumbing Plan Notes

- 2" DIAMETER VENT EXTEND VERTICALLY ON INTERIOR FACE OF WALL TO 3" VENT-THRU-ROOF. FLASH & SEAL ROOF PENETRATION. RUN VENT CONCEALED IN MASONRY WALL AT WASH BAY.
- (2) EXTEND CLEAN-OUT TO GRADE. FURNISH AND INSTALL CAST-IRON MANHOLE COVER AND FRAME.
- (3) EXTEND 2" PVC SANITARY LINE FROM GRINDER PUMP TO EXISTING SEPTIC SYSTEM. SEE SHEET CI.OI FOR
- CONTINUATION.
 3" DIAMETER PVC VENT FROM OIL AND SEDIMENT INTERCEPTOR, EXTEND VERTICALLY ON INTERIOR FACE OF WALL
 TO 3" VENT-THRU-ROOF. FLASH AND SEAL ROOF PENETRATION.



JESTER JONES

Our Marion Office.. 355 East Center Street Suite 200 Marion, Ohio 43302 Phone: (740) 382-6840 Fax: (740) 387-0318 E-mail: marion@jjsa.net

Our Columbus Office.. At Quarry Place 6209 Riverside Drive Suite 200 Dublin, Ohio 43017


Phone: (614) 761-1707 Fax: (614) 761-3996 E-mail: dublin@jjsa.net


(c) 2007 by JESTER JONES SCHIFER ARCHITECTS, LTD. (a) 2001 by JESTEM JONES SCHIEFEN ARCHITECTS, LTD.
THIS DRAMING AND SUBLECT MATTER THEREON,
AS MELL AS THE ASSOCIATED SPECIFICATIONS,
CONSTITUTE THE ORIGINAL AND UNPUBLISHED
WORK OF, AND ARE THE INSTRUMENTS OF
SERVICE OF, JESTEM JONES SCHIFFEN ARCHITECTS,
LTD. (LIJSA) FOR USE SOLLELY MITH RESPECT TO
THIS PROJECT, THESE INSTRUMENTS REMAIN THE
EXCLUSIVE PROPERTY OF JUSA, MYO SHALL
RETAIN ALL COMMON LAW, STATUTORY AND
OTHER RESERVED RIGHTS, INCLUDING THE
COPPRIGHT THERETO, AND MAY NOT BE USED,
REPRODUCED, COPIED, OR ALTERED, IN MYOLE
OR PART, FOR ANY TUPPOSE OR PROJECT
MITHOUT THE WRITTEN CONSENT OF JUSA.


.

GreenKeepe • • • • • • • • • • • • 08590_000 September 18, 2008 DRAWN BY jet CHECKED BY: tfs

REVISIONS

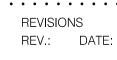

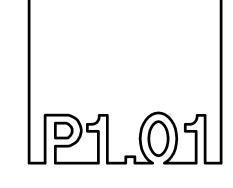

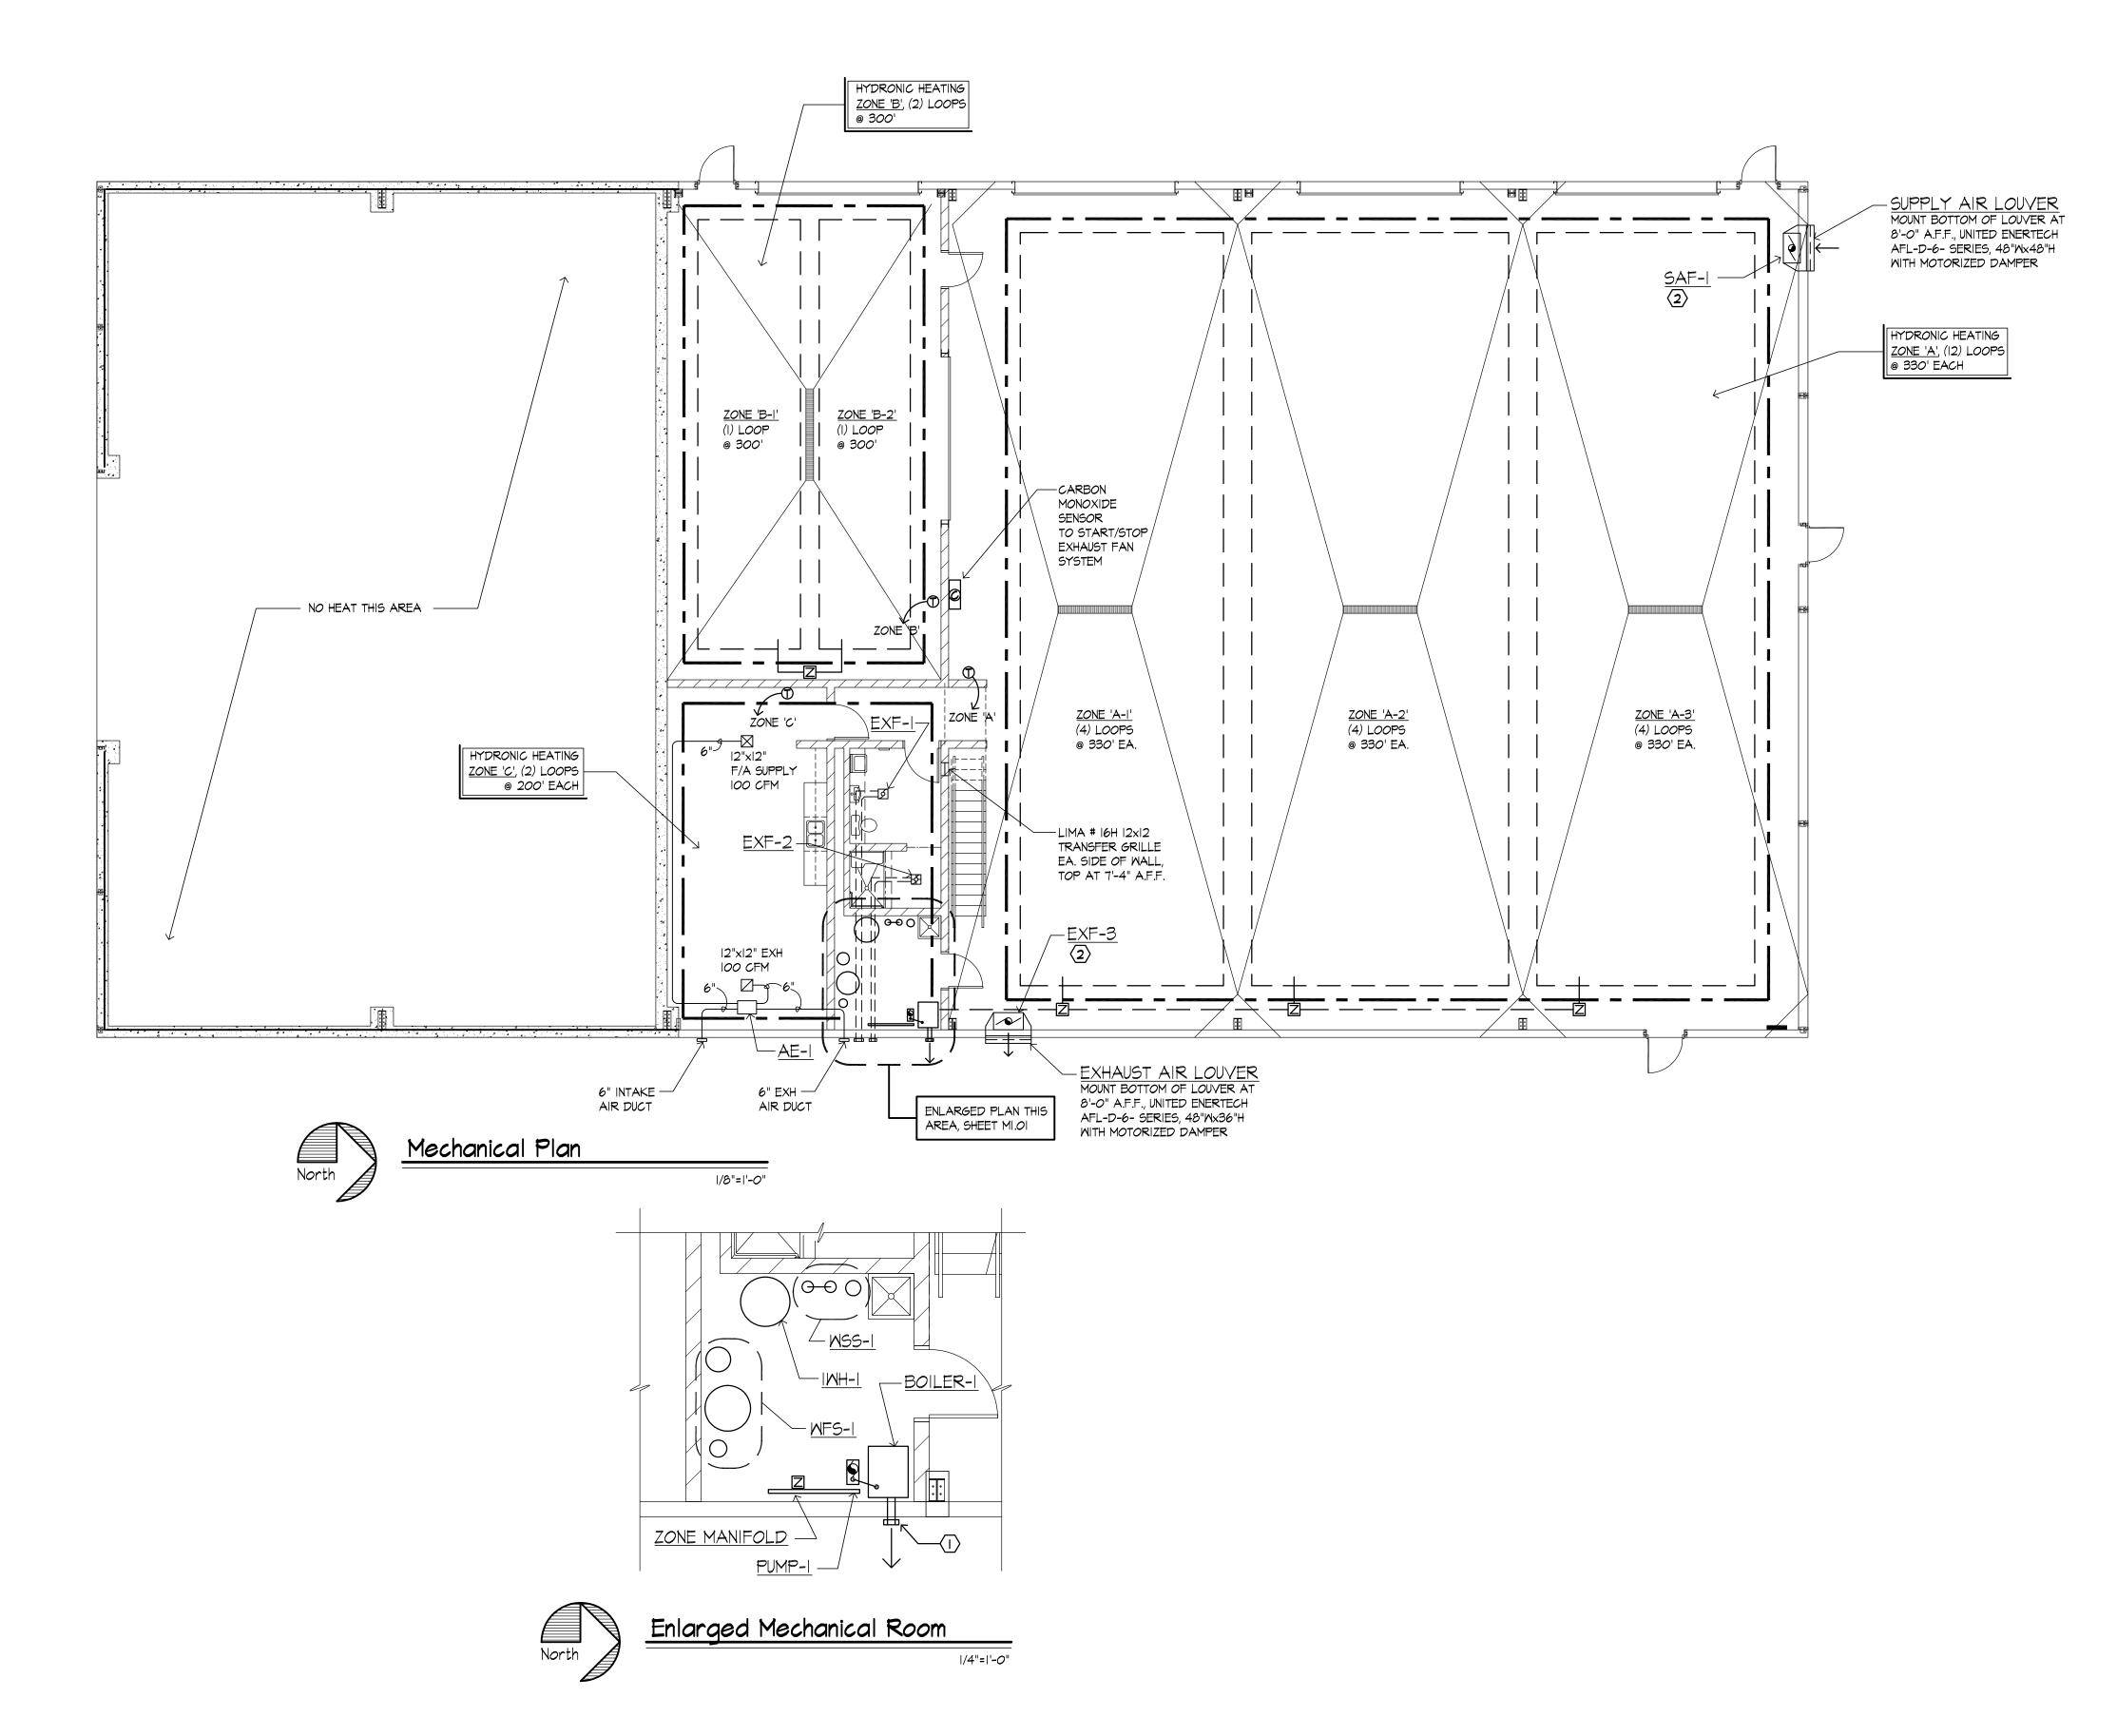

Equipment Notes

BOILER

BURNHAM HYDRONICS #SCG/PVG6, 175,000 BTUH INPUT, 150 MBH DOE HEATING CAPACITY, 85.2 FLUE EFFICIENCY, ENERGY STAR CERTIFIED, LP GAS FIRED, CAST IRON SECTIONAL DESIGN, SEALED COMBUSTION VENTING, POWER VENTED. EXTEND 1/2" LIQUID PETROLEUM FUEL LINE FROM REMOTE TANK LOCATION THRU REGULATOR TO BOILER. FUEL TANK AND PIPING FURNISHED AND INSTALLED BY OTHERS.

PUMP

GRUNDFOS, IN-LINE, SINGLE STAGE, MAINTENANCE FREE, HYDRONIC CIRCULATOR PUMP, MODEL # UP26-96F

HALL

INDIRECT DOMESTIC WATER HEATER, U.S. BOILER COMPANY, INC. - BURNHAM HYDRONICS, ALLIANCE SL, INDIRECT FIRED WATER HEATER, MODEL#AL50SL, 50 GALLON CAPACITY, 220 GALLON/HR RATED, 45 GAL/HR FIRST DRAW, 180 GAL/HR CONTINUOUS DRAW. PROVIDE 3/4" COPPER DOMESTIC WATER INLET AND 3/4" COPPER BOILER WATER SUPPLY AND RETURN. THIS APPLIANCE IS DESIGNED TO HEAT WATER BY CIRCULATING WATER FROM THE BOILER THROUGH THE INTERNAL COIL IN THE TANK.

<u>MFS-1</u>

MATER FILTRATION SYSTEM, CSI MATER TREATMENT, REACTR# RF25. EXTEND WELL WATER INLET LINE THROUGH CHECK VALVE ASSEMBLY TO REACTR TANK, TO WELL PRESSURE TANK, AND TO REACTR FILTER TANK. PRESSURE TANK - WELLMATE# WM-35MB, II9.7 GALLON CORROSION PROOF COMPOSITE CONSTRUCTION WITH REPLACEABLE AIR CELL, HIGH DENSITY POLYETHLYENE INNER SHELL, GLASS FIBER OUTER SHELL, AND I 1/2" HIGH IMPACT PVC INLET/OUTLET

<u> MSS-1</u>

WATER SOFTENING SYSTEM, CSI WATER TREATMENT MODEL# ATI48, ALTERNATING TWIN ELIMINATR SYSTEM WITH FLECK 9000 ALTERNATING CONTROL VALVE.

EXF-I

EXHAUST FAN. BROAN MODEL QTXE 150 CFM, 1.4 SONES, ENERGY STAR RATED. EXTEND 6" ROUND EXHAUST DUCT THROUGH EXTERIOR WALL TO WEATHERPROOF WALL CAP WITH INSECT SCREEN AND BACKDRAFT DAMPER.

EXF-2

COMBINATION EXHAUST FAN/LIGHT. BROAN MODEL QTRE 080 FLT, 80 CFM 1.8 SONES, ENERGY STAR RATED, 42M FLUORESCENT LIGHTING AND 4M NIGHTLIGHT. EXTEND 4" ROUND EXHAUST DUCT THROUGH EXTERIOR WALL TO MEATHERPROOF WALL CAP WITH INSECT SCREEN AND BACKDRAFT DAMPER.

<u>EXF-3</u>

EXHAUST FAN, ACME ENGINEERING AND MANUFACTURING, MODEL DC 30, 1/2 HP, 607 RPM, TWO SPEED, 8570 CFM AT .125 SP. MOUNT FAN IN EXHAUST HOOD SIZED TO FIT LOUVER DIMENSIONS.

SAF-I

SUPPLY AIR FAN ACME ENGINEERING AND MANUFACTURING, MODEL DC 30, 1/2 HP, 607 RPM, TWO SPEED, 8570 CFM AT .125 SP. MOUNT FAN IN INTAKE AIR HOOD SIZED TO FIT LOUVER DIMENSIONS.

<u>AE-I</u>

AIR EXCHANGER, BROAN MODEL #HRV200H HEAT RECOVERY VENTILATOR, 250 CFM MAX, 120V, 1PH. UNIT FURNISHED WITH WASHABLE FILTER AND 6" DIAMETER SUPPLY AIR AND EXHAUST AIR CONNECTIONS. MOUNT UNIT AT MEZZANINE LEVEL, CHAIN HUNG WITH VIBRATION ISOLATORS. RUN ALL DUCTWORK AT MEZZANINE LEVEL AND PENETRATE FLOOR FOR FRESH AIR SUPPLY DIFFUSER AND EXHAUST GRILLES. ALL DUCTWORK TO BE INSULATED WITH MINIMUM I" DUCT WRAP, TAPED AND SEALED. FURNISH SYSTEM COMPLETE WITH ALL INTAKE AND EXHAUST WALL CAPS, BACKDRAFT DAMPERS, WEATHERPROOF CONNECTIONS, AND ALL REQUIRED ACCESSORIES AND COMPONENT PARTS. UNIT TO BE INSTALLED IN STRICT COMPLIANCE WITH MANUFACTURER'S INSTILLATION INSTRUCTIONS.

Mechanical Plan Notes

- EXTEND 4" DIAMETER CONCENTRIC FLUE (COMBUSTION AIR AND EXHAUST), FROM POWER VENTED SEALED COMBUSTION CHAMBER THROUGH BUILDING SIDEWALL TO WEATHERPROOF WALL CAP WITH BACKDRAFT DAMPER.
- SUPPORT FROM STRUCTURE WITH SUPPORT RODS AND VIBRATION ISOLATORS. WIRE FAN THROUGH CARBON MONOXIDE DETECTOR SWITCH AND MANUAL OVERRIDE SWITCH AND INTERLOCK WITH AIR INTAKE LOUVER. SEE ELECTRICAL DRAWINGS

VENTILATION AIR

GARAGE AREA: 75'x75' = 5,625 SF

5,525 SF x 1.5 CFM/SF = 8438 CFM

OMC SECTION 404.2: MAXIMUM RATE OF GARAGE EXHAUST SHALL NOT BE LESS THEN 1.5 CFM/SF.

AUTOMATIC OPERATION OF GARAGE EXHAUST SHALL NOT REDUCE THE VENTILATION

RATE TO LESS THEN 0.05 CFM/SF. THE CO SENSOR ACTIVATES THE MAXIMUM CFM

VENTILATION RATE.



JESTER JONES SCHIFER

ARCHITECTS

Our Marion Office...
355 East Center Street
Suite 200
Marion, Ohio 43302
Phone: (740) 382-6840
Fax: (740) 387-0318

Our Columbus Office..

E-mail: marion@jjsa.net

At Quarry Place
6209 Riverside Drive
Suite 200
Dublin, Ohio 43017
Phone: (614) 761-1707
Fax: (614) 761-3996
E-mail: dublin@jjsa.net

(c) 2007 by JESTER JONES SCHIFER ARCHITECTS, LTD.
THIS DRAMING AND SUBJECT MATTER THEREON,
AS MELL AS THE ASSOCIATED SPECIFICATIONS,
CONSTITUTE THE ORIGINAL AND UNPUBLISHED
WORK OF, AND ARE THE INSTRUMENTS OF
SERVICE OF, JESTER JONES SCHIFER ARCHITECTS,
LTD. (LISA) FOR USE SOLELY WITH RESPECT TO
THIS PROJECT. THESE INSTRUMENTS REMAIN THE
EXCLUSIVE PROPERTY OF JUSA, WHO SHALL
RETAIN ALL COMMON LAM, STATUTORY AND
OTHER RESERVED RIGHTS, INCLUDING THE
COPYRIGHT THERETO, AND MAY NOT BE USED,
REPROJUCED, COPIED, OR ALTERED, IN WHOLE
OR PART, FOR ANY FURCOSE OR PROJECT
WITHOUT THE WRITTEN CONSENT OF JUSA.

Marion, Ohio


Storage Building #5

GreenKeeper Salt Stora

08590_000
September 18, 2008
DRAWN BY: jet
CHECKED BY: tfs

REV.: DATE:



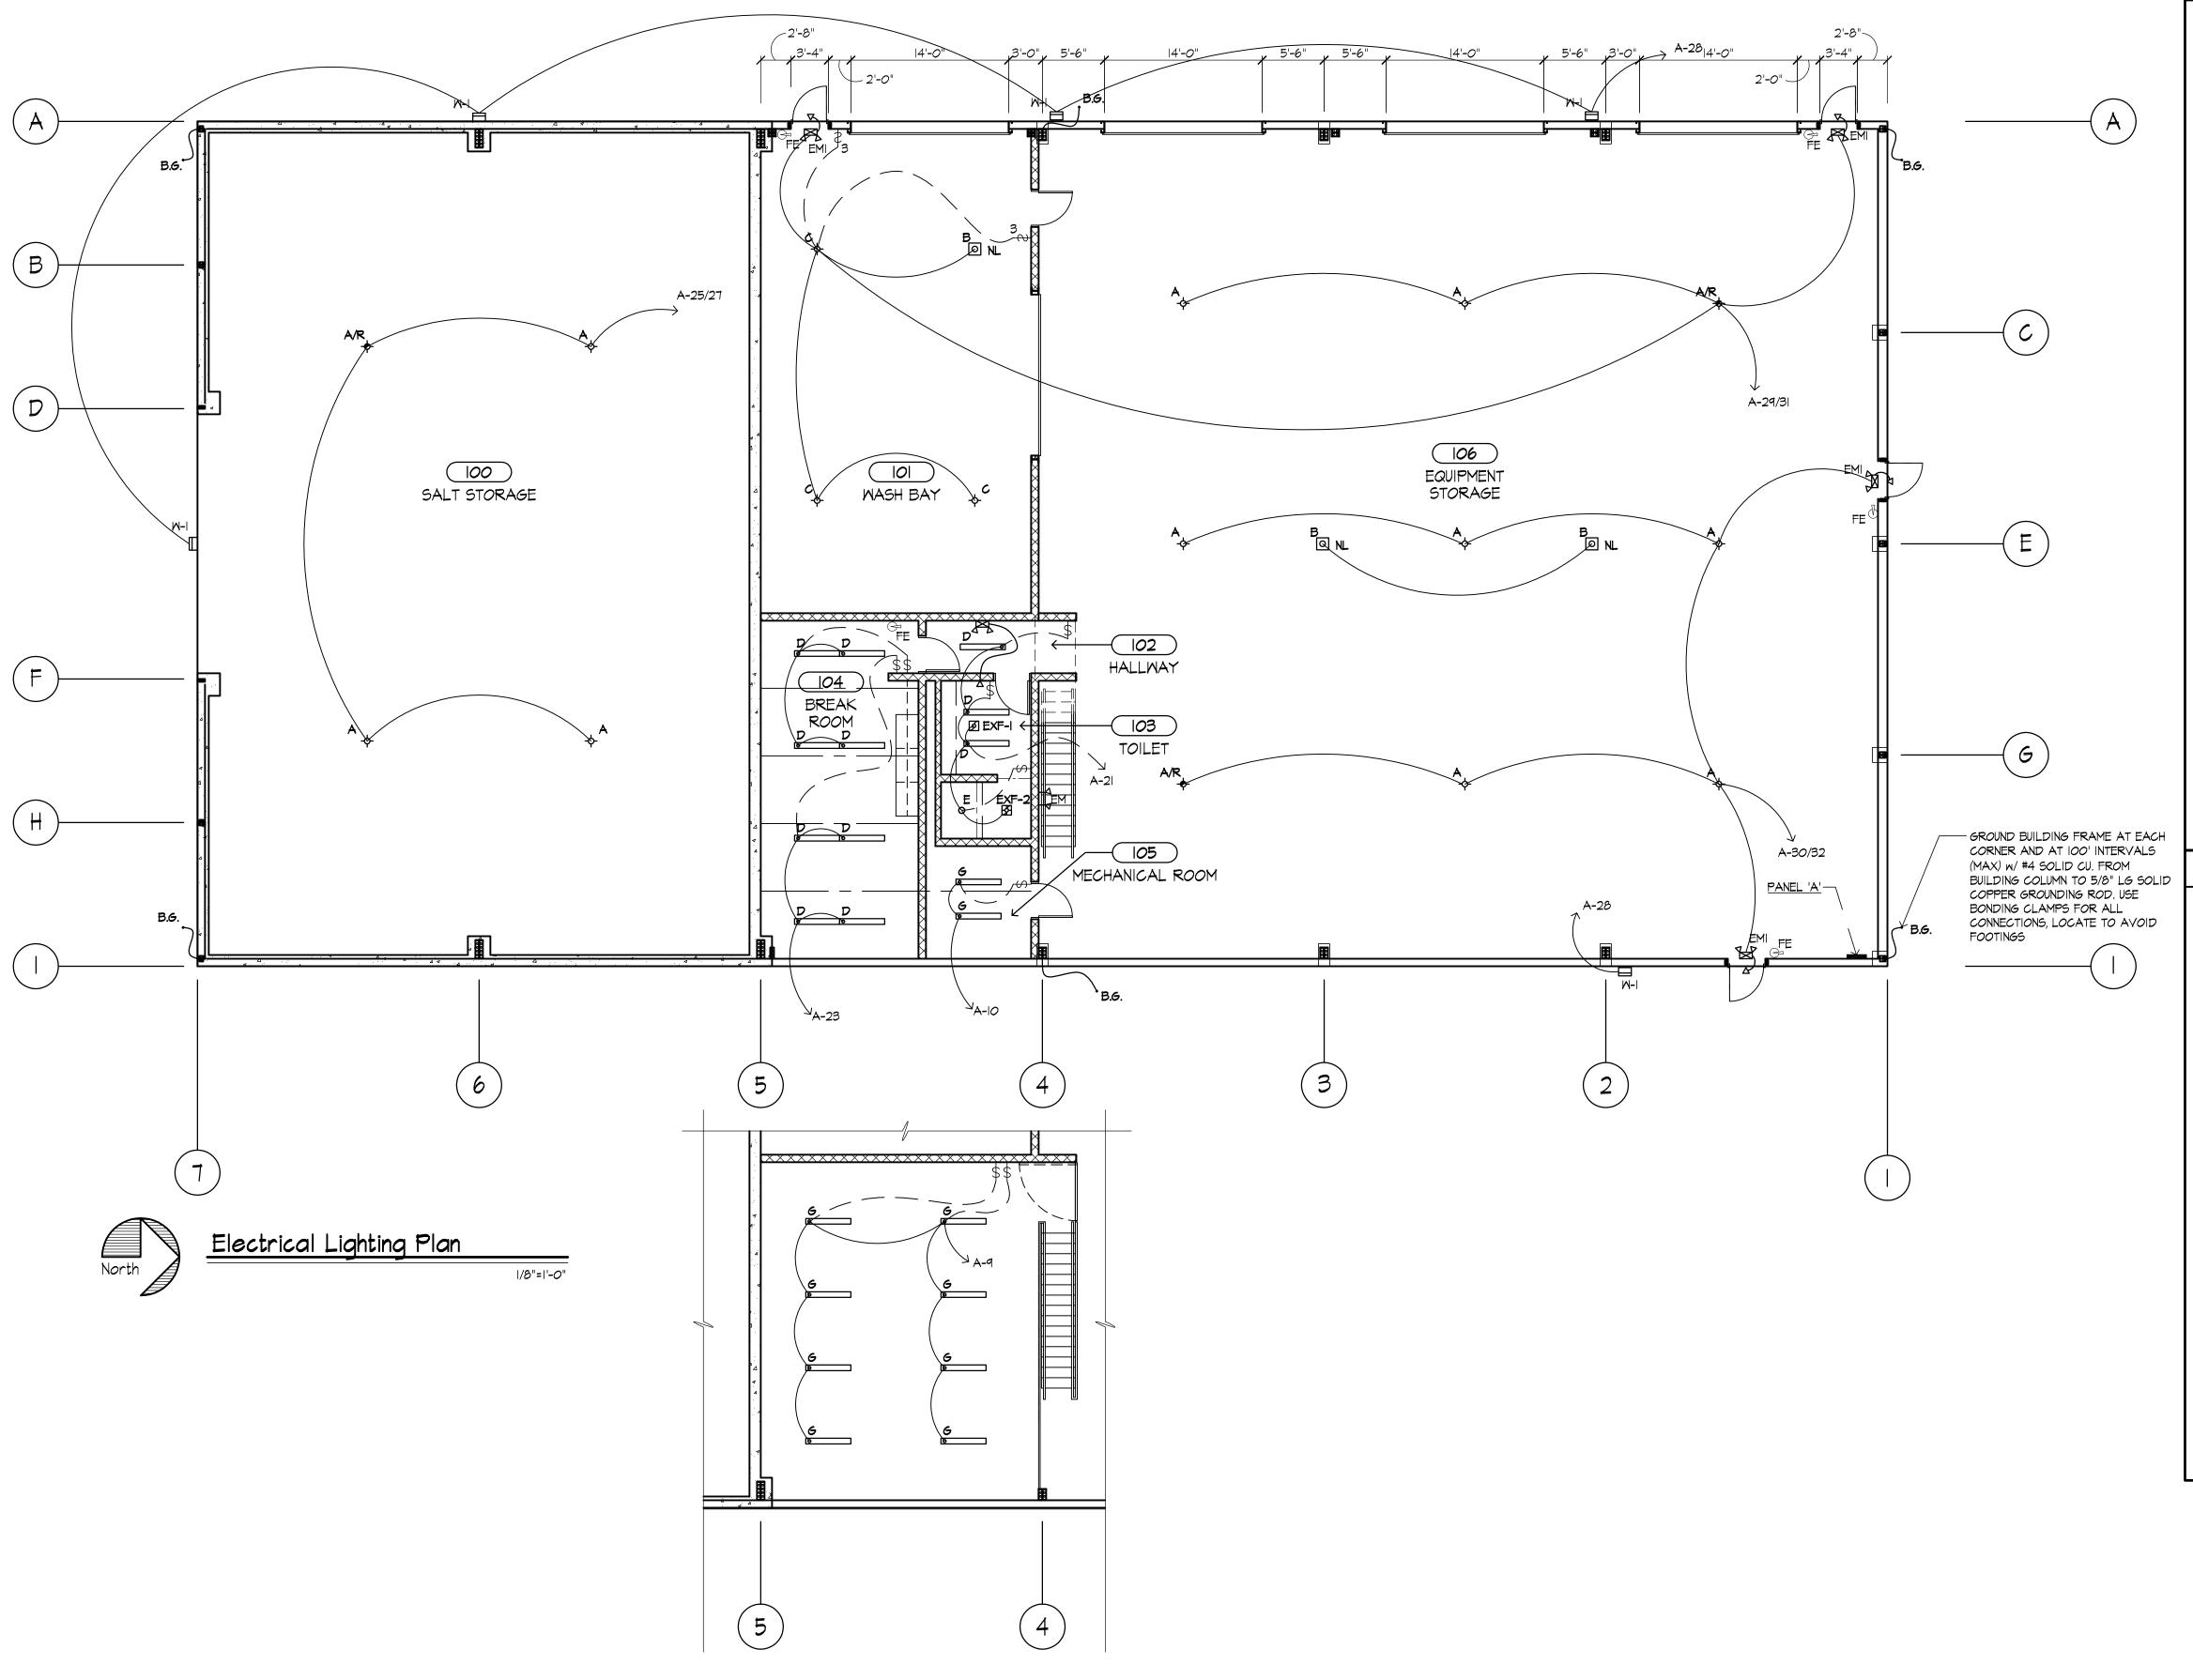

Mez. Electrical Lighting Plan

Lighting Fixture Schedule

INDUSTRIAL LOW BAY, LITHONIA TX 250M A23 TB(120) SCWA QRS, 250W METAL HALIDE, FURNISH WITH QUARTZ RESTRIKE FEATURE, SUSPEND AT 14'-0" MOUNTING HEIGHT TO BOTTOM OF FIXTURE.

INDUSTRIAL LOW BAY, LITHONIA TX 250M A23 TB(120) SCWA, 250W METAL HALIDE, SUSPEND AT 14'-0" MOUNTING HEIGHT TO BOTTOM OF FIXTURE.

B INDUSTRIAL LOW BAY, LITHONIA TX 100M A125 120 SCWA QRS, 100M MWTAL HALIDE, FURNISH WITH QUARTZ RESTRIKE FEATURE. SUSPEND AT 14'-0" MOUNTING HEIGHT TO BOTTOM OF FIXTURE. WIRE AHEAD OF LOCAL SWITCHING.

INDUSTRIAL LOW BAY, LITHONIA TX 175M A23 120 SCWA, 175W METAL HALIDE, SUSPEND AT 14'-0" MOUNTING HEIGHT TO BOTTOM OF FIXTURE.

LITHONIA 2VC232MVOLTGEBIORSVC2MH, SURFACE MOUNTED FLUORESCENT FIXTURE, (2) 32M T8, FURNISH MITH WHITE END CAPS.

LITHONIA LI6F 26TRT 6LD3 MVOLT, RECESSED DOWNLIGHT WITH DROP OPAL LENS, SUITABLE FOR DAMP LOCATIONS, (I) 26M TRIPLE TWIN TUBE, COMPACT FLUORESCENT.

LITHONIA QUANTUM #ELM 654 H2006 N DL WALL MOUNTED , TWIN LAMP, EMERGENCY MEANS
OF EGRESS FIXTURE. FURNISH IN WHITE FINISH WITH MAINTENANCE FREE NICKEL CADMIUM

LITHONIA #LQMSWIRI20 N H WALL MOUNTED EXIT LIGHT WITH BATTERY BACK-UP.
PROVIDE REMOTE HEAD #ELA W CDS ABOVE EXTERIOR DOORS IN LOCATIONS SHOWN

EXHAUST FAN. BROAN MODEL QTXE, 150 CFM, 1.4 SONES, ENERGY STAR RATED. EXTEND 6" ROUND EXHAUST DUCT THROUGH EXTERIOR WALL TO WEATHERPROOF WALL CAP WITH INSECT SCREEN AND BACKDRAFT DAMPER.

EXF-2 COMBINATION EXHAUST FAN/LIGHT. BROAN MODEL QTRE 080 FLT, 80 CFM, I.8 SONES, ENERGY STAR RATED, 42M FLUORESCENT LIGHTING AND 4M NIGHTLIGHT. EXTEND 4" ROUND EXHAUST DUCT THROUGH EXTERIOR WALL TO MEATHERPROOF WALL CAP WITH INSECT SCREEN AND BACKDRAFT DAMPER.

EXHAUST FAN, ACME ENGINEERING AND MANUFACTURING, MODEL DC 30, 1/2 HP, 607 RPM, TWO SPEED, 8570 CFM AT .125 SP. MOUNT FAN IN EXHAUST HOOD SIZED TO FIT LOUVER DIMENSIONS.


SUPPLY AIR FAN ACME ENGINEERING AND MANUFACTURING, MODEL DC 30, 1/2 HP, 607 RPM, TWO SPEED, 8570 CFM AT .125 SP. MOUNT FAN IN INTAKE AIR HOOD SIZED TO FIT LOUVER DIMENSIONS.

6 LITHONIA AFIO 232 MVOLT GEBIORS, CHAIN HUNG FROM STRUCTURE ABOVE.

SECURITY WALL-PACK FIXTURE, LITHONIA TWP-175M-120-PE-LPI-DMB, MOUNT AT 13'-O"

General Electrical Notes

- ALL ELECTRICAL WORK SHALL CONFORM TO THE NATIONAL ELECTRIC CODE, CURRENT EDITION, AND THE OHIO BUILDING CODE (OBC), CURRENT EDITION.
- 2. ELECTRICAL CONTRACTOR SHALL TABULATE LOADS FROM ALL NEW WORK AND VERIFY THAT ELECTRIC SERVICE, PANELS, BREAKERS, AND WIRE ARE PROPERLY SIZED TO HANDLE LOADS. ELECTRICAL CONTRACTOR SHALL SUPPLY AND INSTALL ALL FIXTURES, JUNCTION BOXES, OUTLETS, SWITCHES AND WIRING SHOWN ON THE DRAWINGS AND AS NEEDED FOR A COMPLETE JOB.
- 3. ELECTRICAL CONTRACTOR SHALL INSTALL SERVICE TO NEW EQUIPMENT ONLY FROM APPROVED SHOP DRAWINGS OF SUCH EQUIPMENT, WHICH SHOWS AND DIMENSIONS ALL CONNECTION POINTS. SUBMIT SHOP DRAWINGS SHOWING ALL NEW PANELS, CIRCUITING, BREAKERS, ETC. TO ARCHITECT FOR APPROVAL.
- 4. DIRECT BURIAL PVC CONDUIT MY BE SUBSTITUTED FOR UNDER SLAB WORK IF INSTALLED ACCORDING TO N.E.C. AND APPROVED BY LOCAL AUTHORITIES HAVING JURISDICTION. SWEEP ELBOWS PENETRATING THE CONCRETE SLAB SHALL BE STEEL. NO PVC CONDUIT OF ANY TYPE SHALL BE INSTALLED PENETRATING THE SLAB OR ABOVE SLAB.
- 5. SERVICE ENTRANCE CABLE SIZES ARE BASED ON ALUMINUM. ALL OTHER WIRE SIZES ARE BASED ON COPPER. ALUMINUM WIRE MAY BE SUBSTITUTED FOR COPPER FROM TRANSFORMER TO MAIN SWITCH GEAR (WHERE OCCURS) IF APPROVED BY LOCAL POWER COMPANY. FEEDER WIRE AND CONDUIT FROM SWITCH GEAR TO PANELS MAY BE CHANGED TO ALUMINUM IF RESIZED IN ACCORDANCE WITH N.E.C.
- 6. ALL EXIT AND EMERGENCY EGRESS LIGHTS SHALL BE BATTERY-PACK TYPE, AND SHALL BE WIRED INTO THE NEAREST POWER CIRCUIT AHEAD OF ANY SWITCHING.
- 7. WIRING RUN THRU MASONRY SHALL BE IN CONDUIT. INSTALLED AS THE MASONRY IS LAID UP. WIRING MAY BE RUN IN THE WALL INSULATION SPACE AND MAY BE ROMEX TYPE IF APPROVED BY CODE.
- 8. ALL LIGHT FIXTURES SHALL BE NOTED ON THE FIXTURE SCHEDULE AND CUT SHEETS SHALL BE SUBMITTED TO THE ARCHITECT FOR APPROVAL PRIOR TO ORDERING ANY FIXTURES.
- 9. ELECTRICAL CONTRACTOR SHALL TEST ALL WIRING FOR CONTINUITY AND GROUNDS BEFORE FIXTURE INSTALLATION, AND SHALL THEN TEST THE ENTIRE SYSTEM IN THE PRESENCE OF THE ARCHITECT UPON COMPLETION TO ENSURE THE ABSENCE OF SHORT CIRCUITS AND GROUNDS.
- IO. ALL ELECTRIC PANELS EXPOSED TO VIEW SHALL HAVE THE COVERS AND DOORS PAINTED WITH SEMI-GLOSS PAINT TO MATCH ADJACENT WALLS, AS SPECIFIED UNDER THE PAINTING SPECIFICATIONS.
- II. ALL DUPLEX OUTLETS AND COMMUNICATION JUNCTION BOXES SHALL BE AT 48" ABOVE FINISH FLOOR, UNLESS NOTED OTHERWISE. SWITCH BOXES SHALL BE INSTALLED AT 48" ABOVE FINISH FLOOR TO THE TOP, UNLESS NOTED OTHERWISE. OUTLETS SHALL NOT BE LOCATED IN THE SAME STUD SPACE ON OPPOSITE SIDES OF A COMMON WALL.

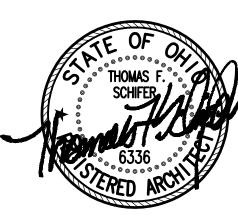

JESTER JONES SCHIFER

Our Marion Office...

355 East Center Street
Suite 200
Marion, Ohio 43302
Phone: (740) 382-6840
Fax: (740) 387-0318
E-mail: marion@jjsa.net

Our Columbus Office..
At Quarry Place

6209 Riverside Drive
Suite 200
Dublin, Ohio 43017
Phone: (614) 761-1707
Fax: (614) 761-3996
E-mail: dublin@jjsa.net

(c) 2001 by JESTER JONES SCHIFFE ARCHITECTS, LTD.

THIS DRAWING AND SUBJECT MATTER THEREON,
AS WELL AS THE ASSOCIATED SPECIFICATIONS;
CONSTITUTE THE ORIGINAL AND UNPUBLISHED
WORK OF, AND ANE THE INSTRUMENTS OF
SERVICE OF, JESTER JONES SCHIFFER ARCHITECTS,
LTD. (LIJSÅ) FOR USE SOLLEY WITH RESPECT TO
THIS PROJECT. THESE INSTRUMENTS REWAIN THE
EXCLUSIVE PROPERTY OF JISA, WHO SHALL
RETAIN ALL COMMON LAM, STATUTORY AND
OTHER RESERVED RIGHTS, INCLUDING THE
COPYRIGHT THERETO, AND MAY NOT BE USED,
REFRODUCED, COPIED, OR ALTERED, IN NHOLE
OR PART, FOR ANY PURPOSE OR PROJECT
WITHOUT THE WRITTEN CONSENT OF JISA.

.

Marion, Ohio


GreenKeeper
GreenKeeper


GreenKe 6000 1798 Marion (

08590_000
September 18, 2008
DRAWN BY: jet
CHECKED BY: tfs

REV.: DATE:



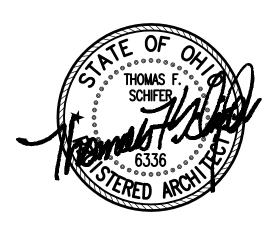

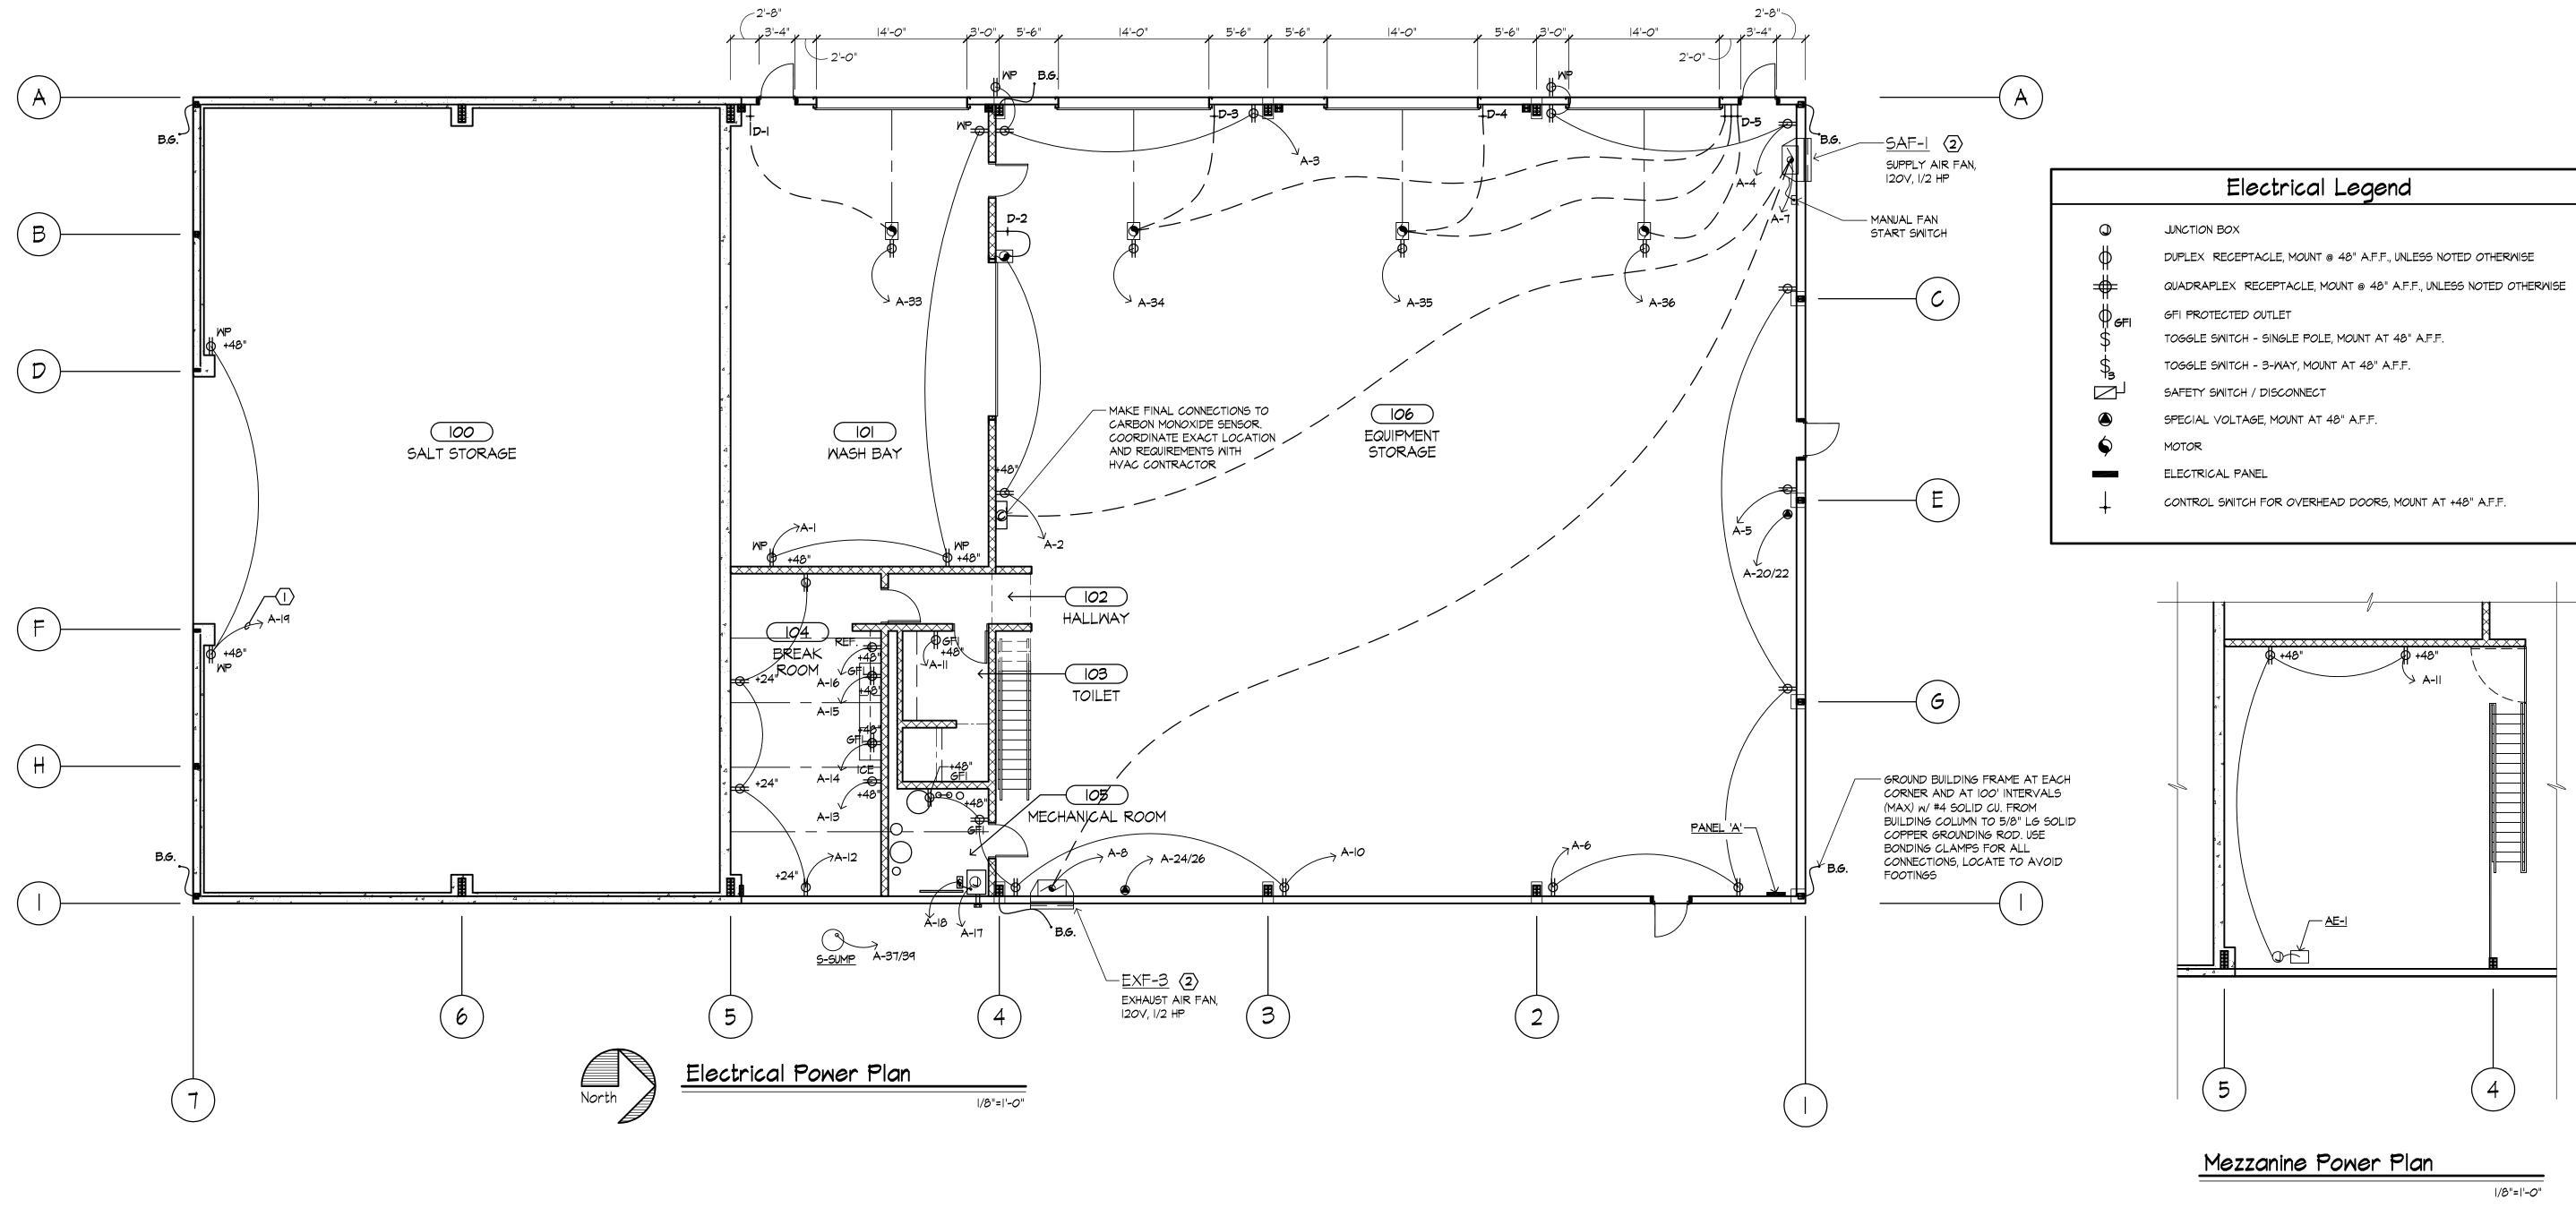

EXISTING 400A | PHASE CENTRAL -DISTRIBUTION SYSTEM MIN. (4) MAIN CIRCUIT BREAKERS WITH A MAXIMUM OF EXISTING 200A, 42 NEW 200A, 42 SPACE SIX BREAKERS (SQUARE "D" I-LINE SPACE PANEL WITH MAIN PANEL WITH MAIN BREAKER LOCATED BREAKER (INSIDE BLDG.) SERIES) LOCATED IN BUILDING #4, SEE INSIDE BUILDING #4 SHEET CI.OI 3" CONDUIT w/ (3) 500 MCM -PANEL PANEL CENTRAL DISC. (BLDG. #5) SYSTEM (BLDG. #4) METER --2-1/2" CONDUIT w/ (3) #3/0 AND (1) #1/0 GROUND NEW 400A | PHASE -UNDERGROUND SERVICE (3) #1/0 CU GROUND WIRE #1/0 CU GROUND WIRE DOWN TO 3/4"x10" 500 MCM IN 3" CONDUIT TO DOWN TO 3/4"x10" COPPER GROUND ROD PAD MOUNT. TRANS. SEE COPPER GROUND ROD AND BONDED CLAMP AND BONDED CLAMP SITE PLAN FOR LOCATION NEW SERVICE, (3) #4/0 AND (1) #I/O GROUND IN 2 I/2" CONDUIT - NEW 200A, 120/240V SINGLE PHASE SERVICE UNDERGROUND - SEE SHEET CI.OI, SITE FROM EXIST.CENTRAL DISCONNECT PLAN FOR CONTINUATION AT BLDG. #4 TO NEW 200A PANEL IN NEW BUILDING #5

PANEL NO .	2	200	AM	(P_	10,	000	_A.I.C.	TRIM FLUSH SURFACE
A = A	120	/240	_V <i>O</i> L	.T, _	<u> </u> Ø	, <u>3</u> W,	<u>60</u> HZ.	□M/ GROUND BUS ■M/ MAIN CIRCUIT BREAKER
, ,	FED F	FROM_		L	OCA	TION_		□w/ SOLID NEUTRAL
TYPE		BREA						□M/ MAIN LUGS ONLY
LOAD	WIRE SIZE	CB/P	CIR. NO.		UR NO.	CB/P	MIRE SIZE	LOAD
WASH BAY RECEPT (GFIC)	12	20/1	- 1	•	2	20/I	12	SOUTH MECH RECEPT/DR D2
MECHANICS RECEPT	12	20/1	3		4	20/I	12	MECHANICS RECEPT
MECHANICS RECEPT	12	20/1	5	•	6	20/1	12	MECHANICS RECEPT
SUPPLY AIR FAN	12	20/1	7	•	8	20/1	12	EXHAUST AIR FAN
MEZZANINE	12	20/1	9		10	20/1	12	MECHANICAL ROOM
BATH (GFIC)	12	20/1	Ш		12	20/1	12	BREAK ROOM RECEPT
ICE MACHINE	12	20/1	13	•	14	20/1	12	RIGHT BREAK RM COUNTER
LEFT BREAK RM COUNTER	12	20/1	15		16	20/1	12	REFRIGERATOR
BOILER	12	20/1	17	•	18	20/1	12	HOT WATER PUMPS
SALT BIN RECEPT	12	20/1	19	•	20	50/	6	WELDER
BATH AND HALL LIGHTS	12	20/1	21		22	/2		
BREAK ROOM LIGHTS	12	20/1	23	•	24	30/	8	AIR COMPRESSOR
SALT STORAGE LIGTHS	10	20/	25	•	26	/2		
		/2	27		28	20/1	12	OUTSIDE PERIMETER LIGHTS
WASH BAY LIGHTS	10	30/	29	•	30	30/	10	MECHANICS LIGHTS
MECHANICS LIGHTS		/2	31	•	32	/2		
O.H. DOOR DI	12	20/1	33		34	20/1	12	0.H. D00R D3
0.H. DOOR D4	12	20/1	35	•	36	20/1	12	0.H. DOOR D5
SEMAGE	10	20/	37		38	20/1	12	SPARE
SUMP		/2	39		40	30/	10	WELL PUMP
SPARE	12	20/1	41	•	42	/2		

New Work Notes

WIRE TO GFIC CIRCUIT BREAKER

MAKE ALL FINAL CONNECTIONS TO THE SUPPLY AIR FAN AND EXHAUST AIR FAN AS NECESSARY, COORDINATE EXACT LOCATION AND ALL ROUGH-IN AND FINAL WIRING REQUIREMENTS WITH THE HVAC CONTRACTOR PRIOR TO ROUGH-IN. THE SAF-I IS MANUALLY OPERATED BY SWITCH AND INTERLOCKED WITH EXF-3. THE EXF-3 IS INTERLOCKED WITH SAF-I AND THE GAS MONITORING SYSTEM. FOR AUTOMATIC START/STOP LOUVERS ARE EQUIPPED WITH MOTORIZED DAMPERS TO INTERLOCK WITH FAN OPERATION. THE TWO SPEED MOTOR FANS SHALL RUN AT HALF SPEED FOR NORMAL OPERATION AND FULL SPEED FOR CO SENSOR ACTIVATION TO ACHIEVE THE FULL VENTILATION RATE.

JESTER JONES SCHIFER

ARCHITECT

Our Marion Office...
355 East Center Street
Suite 200
Marion, Ohio 43302
Phone: (740) 382-6840
Fax: (740) 387-0318
E-mail: marion@jjsa.net

Our Columbus Office...
At Quarry Place
6209 Riverside Drive
Suite 200
Dublin, Ohio 43017
Phone: (614) 761-1707
Fax: (614) 761-3996
E-mail: dublin@jjsa.net

(c) 2007 by LESTER JONES SCHIFER ARCHITECTS, LTD.
THIS DRAWING AND SUBLECT MATTER THEREON,
AS WELL AS THE ASSOCIATED SPECIFICATIONS,
CONSTITUTE THE ORIGINAL AND UNPULSHED
WORK OF, AND ARE THE INSTRUMENTS OF
SERVICE OF, LESTER, JONES SCHIFER ARCHITECTS,
LTD. (JJSA) FOR USE SOLELY WITH RESPECT TO
THIS PROJECT. THESE INSTRUMENTS REMAIN THE
EXCLLISIVE PROPERTY OF JJSA, WHO SHALL
RETAIN ALL COMMON LAW, STATUTORY AND
OTHER RESERVED RIGHTS, INCLIDING THE
COPYRIGHT THERETO, AND MAY NOT BE USED,
REPRODUCED, COPIED, OR ALTERED, IN WHOLE
OR PART, FOR ANY PURPOSE OR PROJECT
WITHOUT THE WRITTEN CONSENT OF JJSA.

GreenKeeper
GreenKeeper
GreenKeeper
1798 Marion Cardington Rd. East

08590_000
September 18, 2008
DRAWN BY: jet
CHECKED BY: tfs

REV: DATE:

写1.02

Power Riser Diagram